



ବିହାର - ଭାଷାନ୍ତର

୧୯୮୨ ମେ ଶକ୍ତି

ବିହାର ଜାତି ବିଭାଗ ପାଠ୍ୟ ମୂଲ୍ୟାଙ୍କଣ

ବିହାର ମୁଖ୍ୟ ମନ୍ତ୍ରୀଳସ

ମୁଖ୍ୟ ମନ୍ତ୍ରୀଳସ

ବିହାର ମୁଖ୍ୟ ମନ୍ତ୍ରୀଳସ ପାଠ୍ୟ ମୂଲ୍ୟାଙ୍କଣ

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ବିହାର ମୁଖ୍ୟ ମନ୍ତ୍ରୀଳସ



THE JOURNAL OF CLIMATE

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- امرت مسلم افغانستان
- ریاست عوامی افغانستان
- محلیت طلی و اداری
- ریاست طرح و نیاز افغانستان
- امرت مهندس

لیاقت اسلامی ادارہ امور
ریاست عمارت مسجد اسلامی
عمرانیت مسجد اسلامی
ریاست مسجد اسلامی اور
کمیٹی


Designed by:	Obaidullah Warkak	No.	Submission Date:
Drawn by:	Obaidullah Warkak	01	For Construction
Checked By:	Abdul Basir Ramli		Date:
Head of Department:			1403/04/15
Approved by:	Ph.D Hasmahmudah Aunur	Contract No:	
Via Committee:		Contract Date:	
		Fiscal Year:	1403/14/45
		Drawn Code:	SDCBA
		Paper Size:	A3
		Plot Date:	1403/04/07
		Scale:	

SERVICES DIRECTORATE COMPLEX BUILDING AOP KABUL PROVINCE, AFGHANISTAN	
POWER PLANT INDEX SHEET	G-001
Sheet Number	

1. *Leucosia* *leucostoma* *leucostoma*
2. *Leucosia* *leucostoma* *leucostoma*
3. *Leucosia* *leucostoma* *leucostoma*
4. *Leucosia* *leucostoma* *leucostoma*
5. *Leucosia* *leucostoma* *leucostoma*
6. *Leucosia* *leucostoma* *leucostoma*
7. *Leucosia* *leucostoma* *leucostoma*
8. *Leucosia* *leucostoma* *leucostoma*
9. *Leucosia* *leucostoma* *leucostoma*
10. *Leucosia* *leucostoma* *leucostoma*

GENERAL NOTE:
 1. ALL DIMENSIONS ARE IN MM UNLESS OTHERWISE SPECIFIED.
 2. ALL LEVELS ARE IN METER (M) UNLESS OTHERWISE SPECIFIED.
 3. ALL FOUNDATION WALL ARE STONE PATCHING AS PER STRUCTURE.
 4. G(05,06,07) FILLING SHOULD BE COMPACTED BASED ON STRUCTURAL REQUIREMENT.
 5. D2 AS MAINTENANCE DOOR.

ROOM SCHEDULE		
NO	Name	Area
G-01	COOLING CHAMBER	38 m ²
G-02	STORAGE	7 m ²
G-03	IHENCH FOR 12000 CAUILL	10 m ²
G-04	0.4 KV ROOM	12 m ²
G-05	15000 ROOM	9 m ²
G-06	EMPTY SPACE	16 m ²

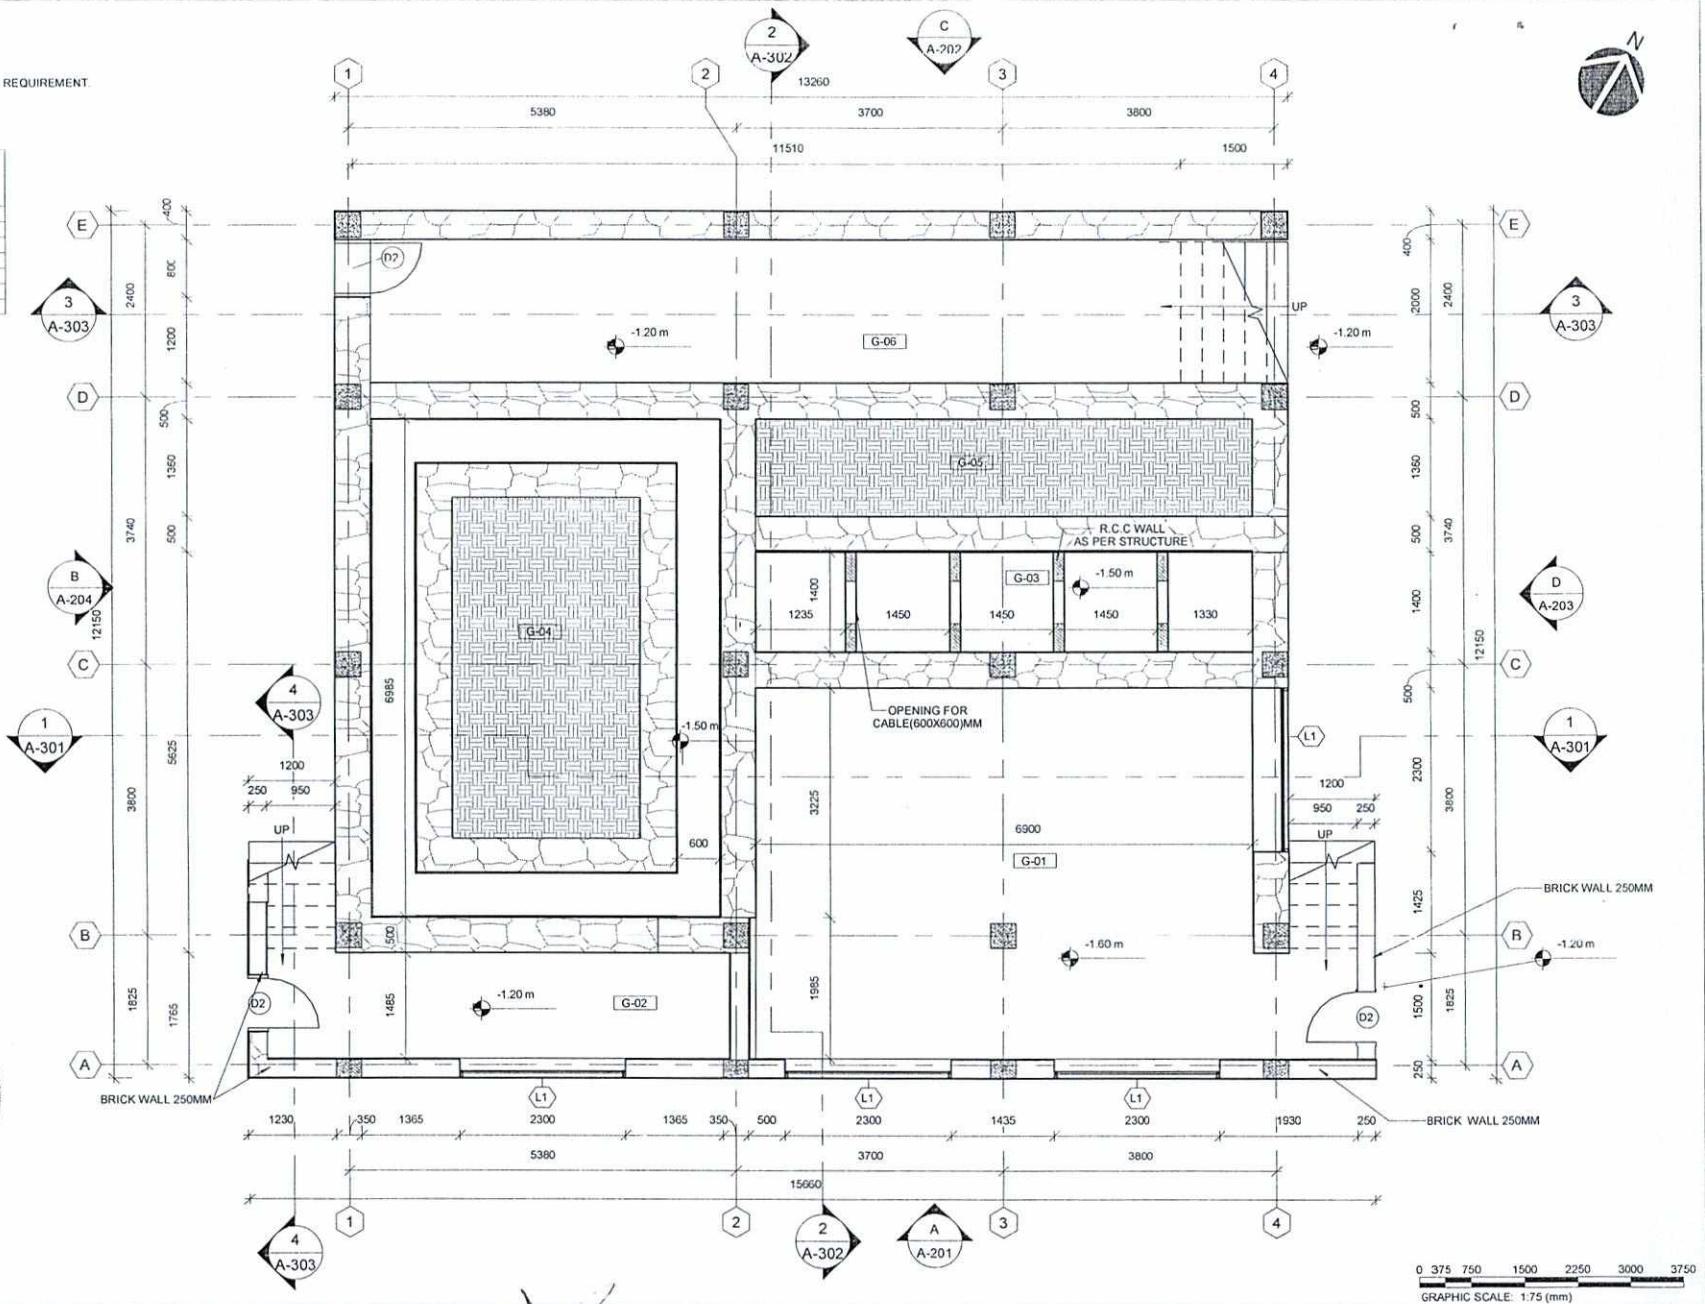

1 STONWORK PLAN

A-101 Ref: SITE PLAN Scale: 1 : 75



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 امریکت مهندسی

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Designed by:	Obaidullah Wardak	No.	Submission Description:	Date:
Drawn by:	Obaidullah Wardak	(01)	For Construction	1403/04/15
Checked By Head of Department:	Abdul Basir Rahimi			
Approved by Visa Committee	Ph.D Hashmatullah Almar			

Contract No:	
Contract Date:	
Fiscal Year:	1403/1445
Drawn Code:	SDCBA
Paper Size:	A3
Plot Date:	1403/04/09
Scale:	1 : 75

SERVICES DIRECTORATE COMPLEX BUILDING AOP
 KABUL PROVINCE , AFGHANISTAN

POWER PLANT
 STONWORK PLAN

Sheet Reference Number
 A-101

GENERAL NOTE:
 1. ALL DIMENSIONS ARE IN MM UNLESS OTHERWISE SPECIFIED.
 2. ALL LEVELS ARE IN METER (M) UNLESS OTHERWISE SPECIFIED.
 3. ALL WALL ARE BRICK MASONRY.



FINISHING SCHEDULE LEGEND

CEILING FINISHING

C1	CEMENT PLASTER 15MM, M(1:4), ONE LAYER PRIMER COAT (FILLING) & 75% PLASTIC PAINT TWO COATS
----	--

FLOOR FINISHING


F1	TERRAZZO TILE (300X300X25) MM, CEMENT MORTAR 40MM M(1:4)
----	--

WALL FINISHING

W1	INTERIOR SIDE (PAINTED 100% TWO-LAYER, FILLING, PLASTER 15MM, M(1:4). EXTERIOR SIDE (PAINTED 100% TWO-LAYER, PRIMER CAD, PLASTER 15MM, M(1:4).
W2	(PAINTED 100% TWO-LAYER, FILLING, PLASTER 15MM, M(1:4).

Finishing Schedule Floor PLAN

ROOM	USAGE	Area	WALL	FLOOR	CEILING
F-01	Tr. ROOM	12 m ²	W1,W2	F1	C1
F-02	Tr. ROOM	12 m ²	W1,W2	F1	C1
F-03	0.4 KV ROOM	36 m ²	W1	F1	C1
F-04	MV SWITCHGEAR	24 m ²	W1,W2	F1	C1
F-05	VERANDA	11 m ²	W1	F1	C1
F-06	ROOM FOR ATTENDANT	6 m ²	W1	F1	C1
F-07	SAFETY EQUIPMENT ROOM	4 m ²	W1	F1	C1
F-08	VERANDA	28 m ²	W1	F1	C1

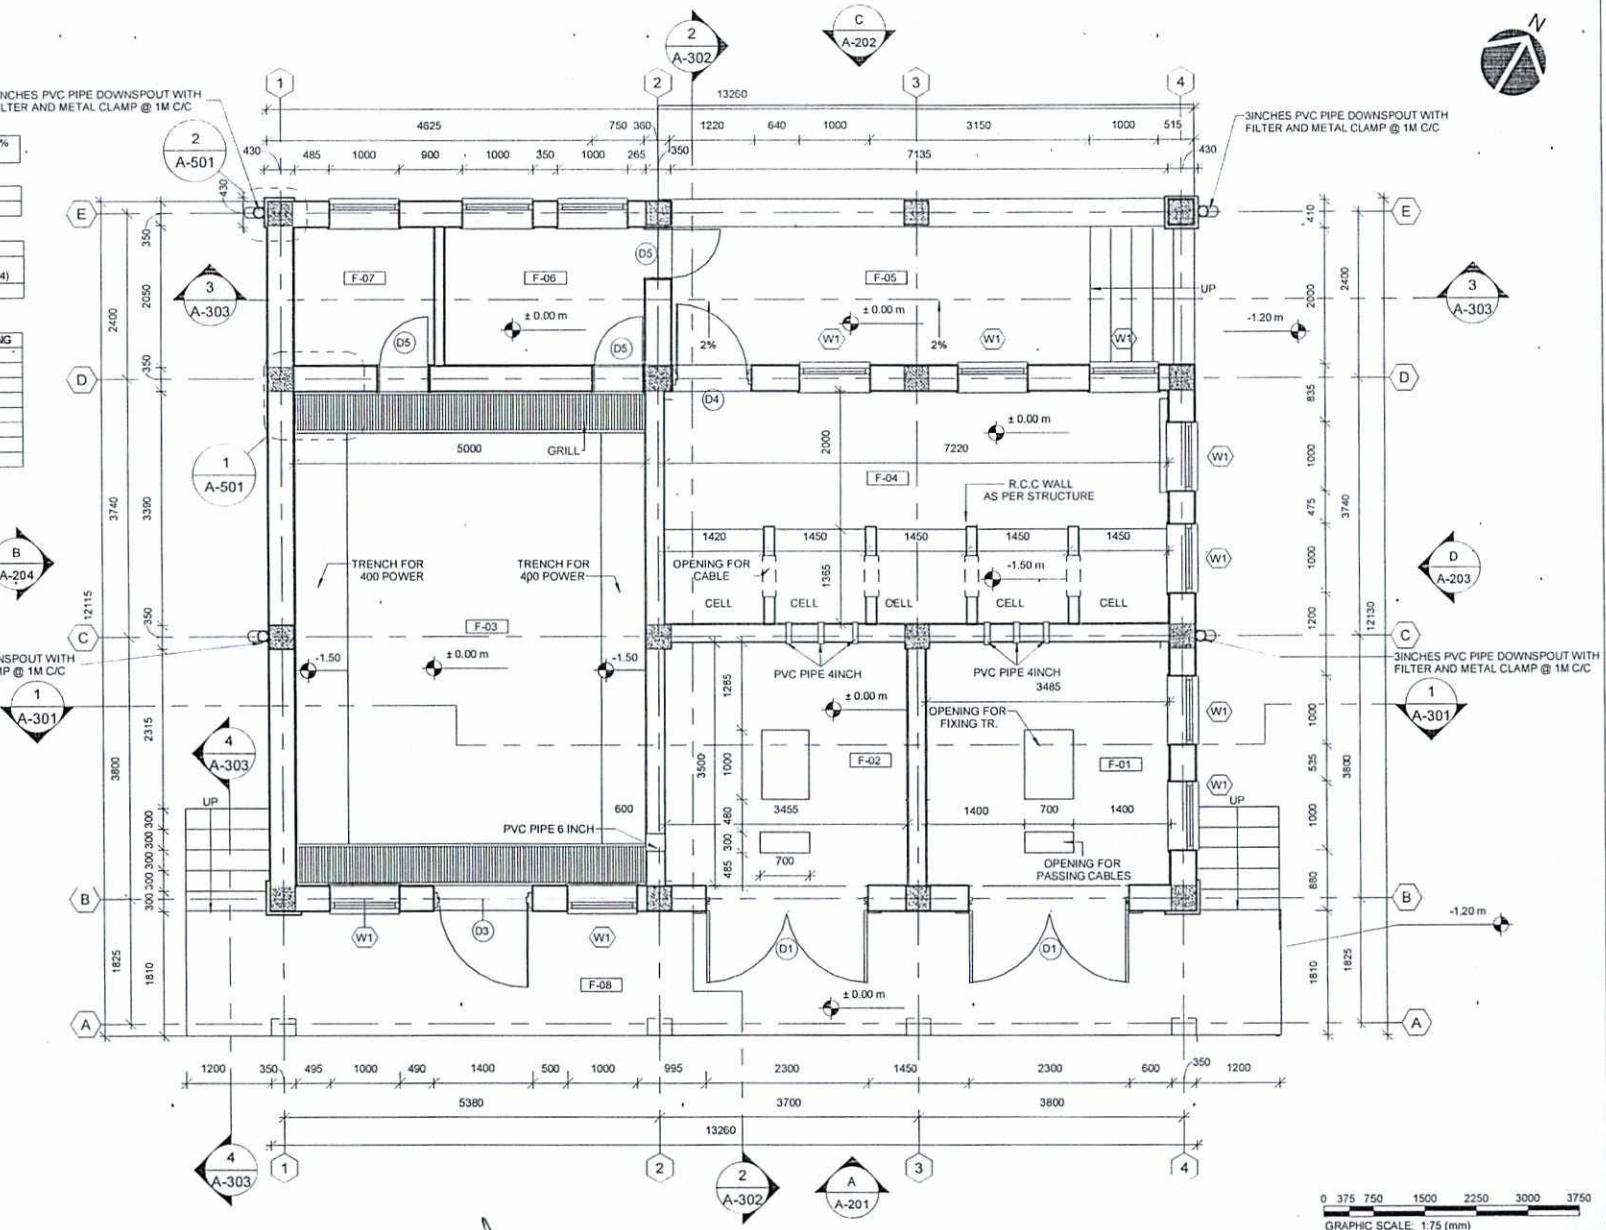

1 FLOOR FINISHED LEVEL

A-102 Ref: A-101 Scale: 1:75

GRAPHIC SCALE: 1:75 (mm)



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 امریکہ ملکی

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Approved by Visa Committee:	Ph.D Hashmatullah Atmar

No.	Submission Description	Date
(D1)	For Construction	1403/04/15


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Contract Date:	
Fiscal Year:	1403/1445
Drawn Code:	SDCBA
Paper Size:	A3
Plot Date:	1403/04/09
Scale:	1:75

SERVICES DIRECTORATE COMPLEX BUILDING AOP KABUL PROVINCE , AFGHANISTAN
POWER PLANT
FLOOR PLAN

Sheet Reference Number
A-102

GENERAL NOTE:
1. ALL DIMENSIONS ARE IN MM UNLESS OTHERWISE SPECIFIED.
2. ALL LEVELS ARE IN METER (M) UNLESS OTHERWISE SPECIFIED.
3. ROOF COVER WITH ISOGUM WITH FOIL.

The Zeta logo consists of a stylized letter 'Z' with a small circle at the top right corner.

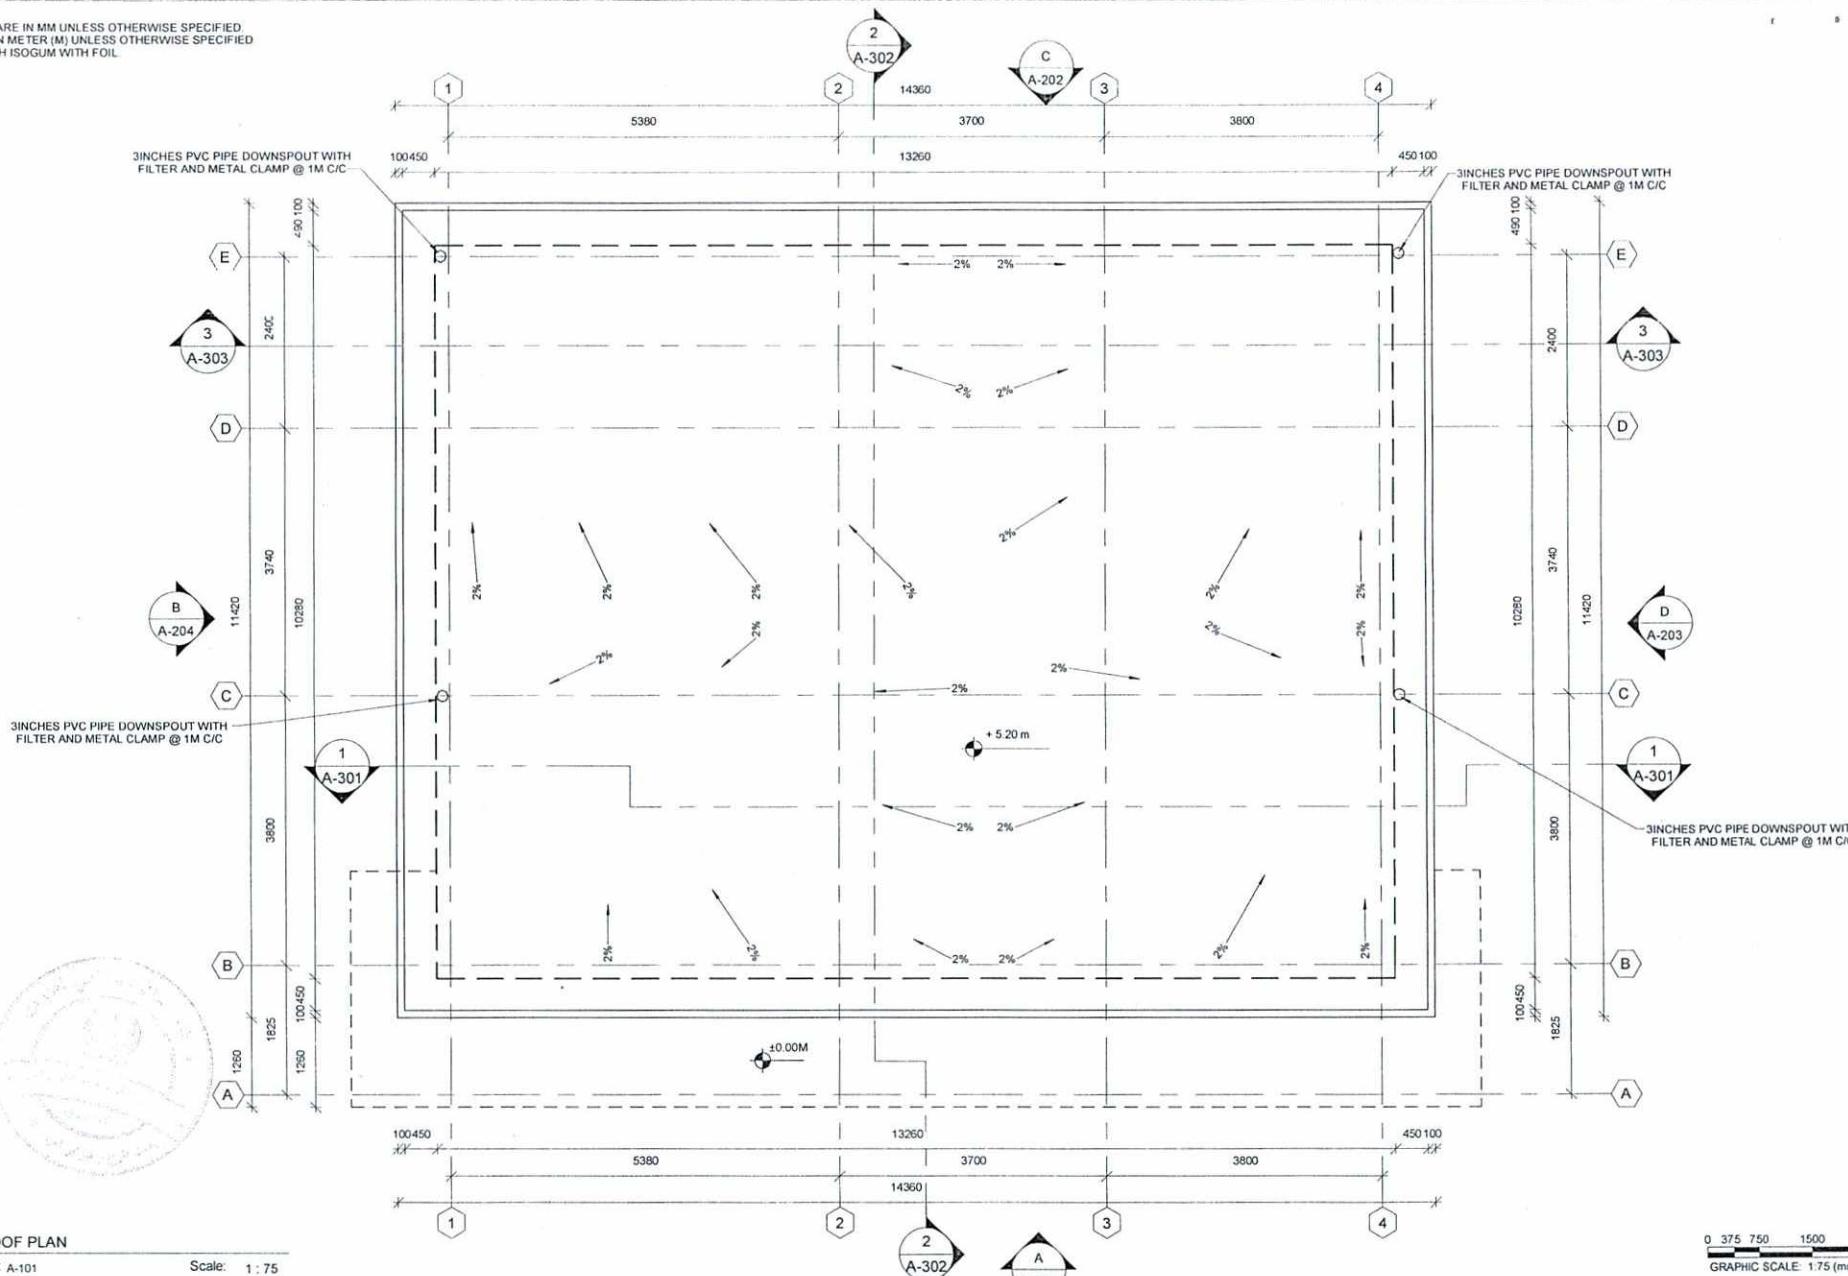

1 ROOF PLAN



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امانت مندی

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Drawn by:	Obaidullah Wardak	(01)	For Construction	1403
Checked By Head of Department :	Abdul Basir Rahimi			
Approved by Visa Committee:	Ph.D Hashmatullah Atmar			



Contract No:	
Contract Date:	
Fiscal Year:	1403/1445
Drawn Code:	SDCBA
Paper Size:	A3
Plot Date:	1403/04/09
Scale:	1 : 75

SERVICES DIRECTORATE COMPLEX BUILDING AOP
KABUL PROVINCE , AFGHANISTAN

POWER PLANT


A-103

GENERAL NOTE:
 1. ALL DIMENSIONS ARE IN MM UNLESS OTHERWISE SPECIFIED.
 2. ALL LEVELS ARE IN METER (M) UNLESS OTHERWISE SPECIFIED.
 3. GAZAK STONE SHOULD HAVE 15MM GROUT IN BETWEEN EACH TILE.
 4. GAZAK STONE WHEN USED IN ELEVATION SHOULD BE POLISHED.

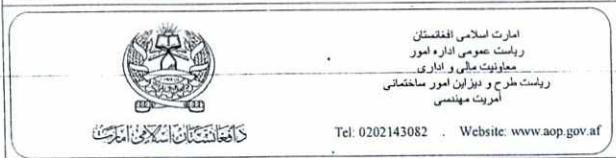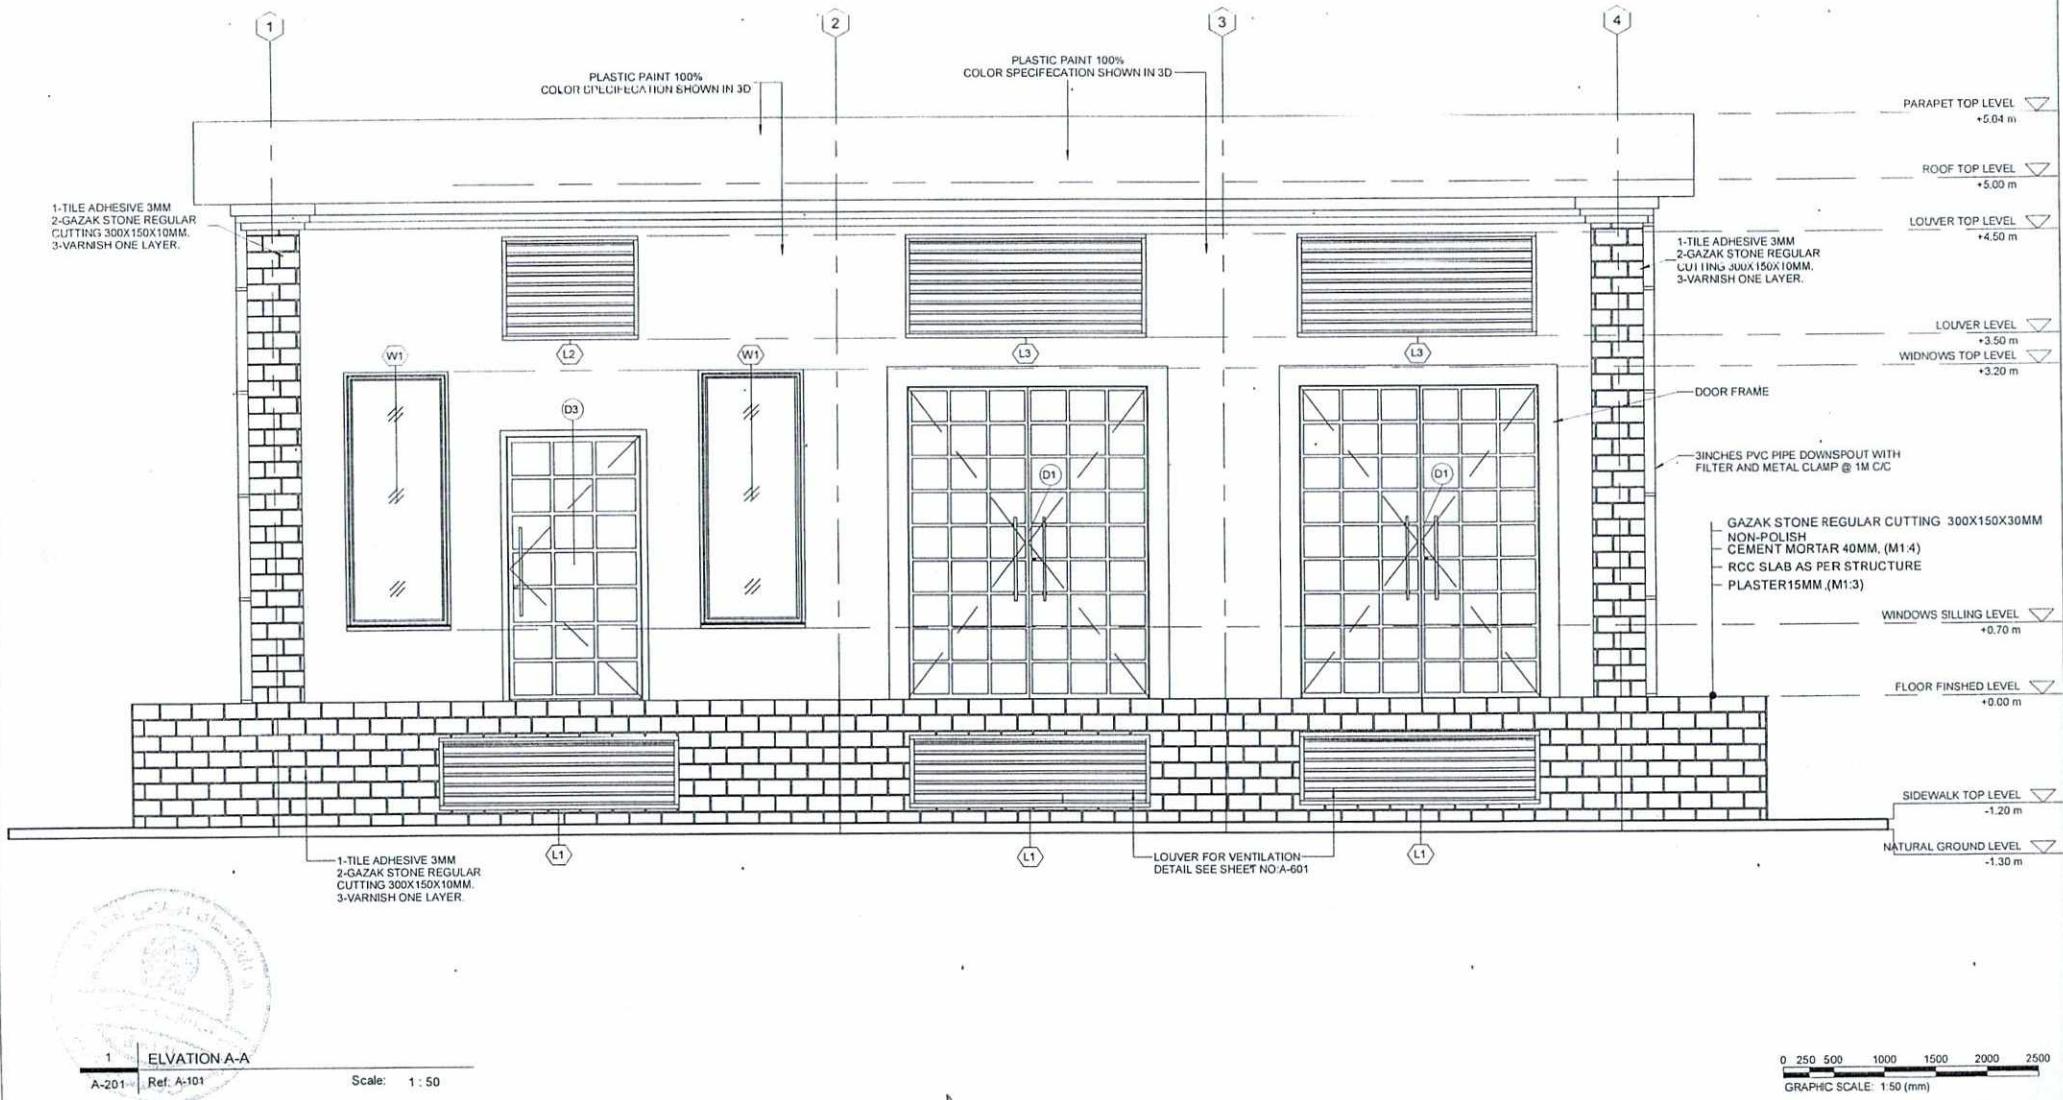

Designed by: Drawn by: Checked By Head of Department: Approved by Visa Committee:	Obardullah Wardak Obardullah Wardak Abdul Basir Rahimi Ph.D Hashmatullah Almar	No. Submission Description Date: (01) For Construction 1403/04/15	Contract No: Contract Date: Fiscal Year: Drawn Code: Paper Size: Plot Date: Scale:	SERVICES DIRECTORATE COMPLEX BUILDING AOP KABUL PROVINCE , AFGHANISTAN POWER PLANT ELEVATION A-A	Sheet Reference Number: A-201
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GENERAL NOTE:
 1. ALL DIMENSIONS ARE IN MM UNLESS OTHERWISE SPECIFIED.
 2. ALL LEVELS ARE IN METER (M) UNLESS OTHERWISE SPECIFIED.
 3. GAZAK STONE SHOULD HAVE 15MM GROUT IN BETWEEN EACH TILE.
 4. GAZAK STONE WHEN USED IN ELEVATION SHOULD BE POLISHED.

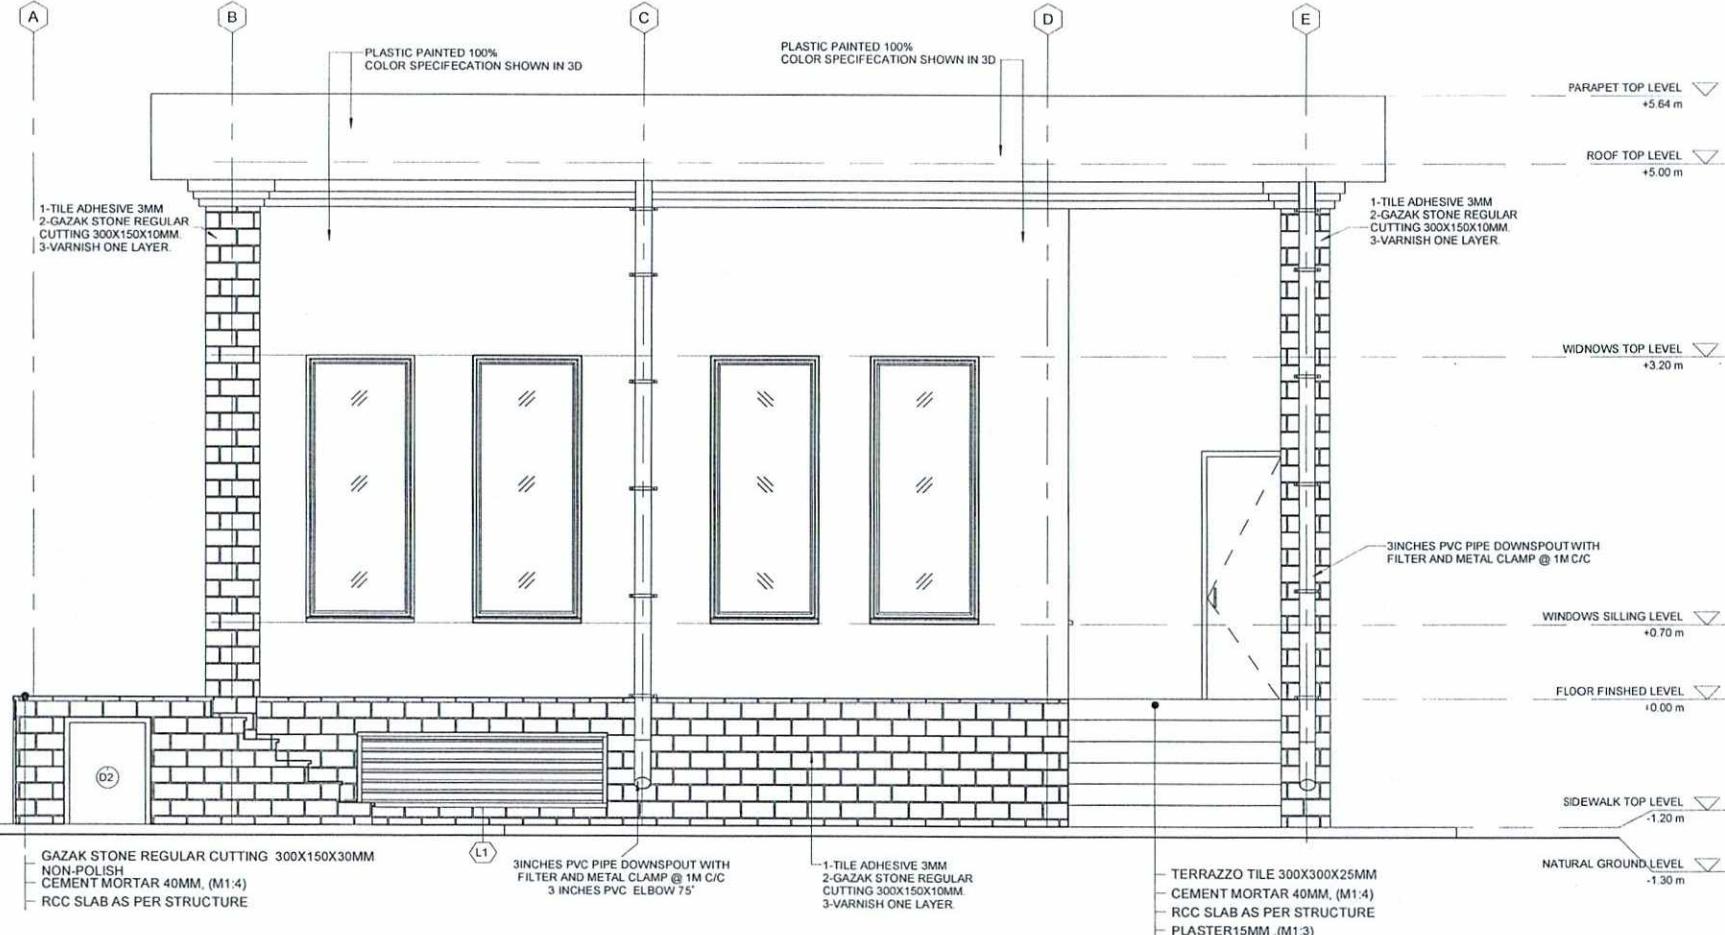

1 ELEVATION D-D

A-203 Ref: A-101

Scale: 1 : 50

0 250 500 1000 1500 2000 2500
GRAPHIC SCALE: 1:50 (mm)



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Designed by:	Obaidullah Wardak	No:	Submission Description:	Date:
Drawn by:	Obaidullah Wardak	(01)	For Construction	1403/04/15
Checked By Head of Department:	Abdul Basir Rahimi			
Approved by Visa Committee:	Ph.D Hashmatullah Almar			

Contract No:	
Contract Date:	
Fiscal Year:	1403/1445
Drawn Code:	SDCBA
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Scale:	1 : 50


SERVICES DIRECTORATE COMPLEX BUILDING AOP
KABUL PROVINCE , AFGHANISTAN

POWER PLANT
ELEVATION D-D

Sheet Reference Number

A-203

GENERAL NOTE:
 1. ALL DIMENSIONS ARE IN MM UNLESS OTHERWISE SPECIFIED.
 2. ALL LEVELS ARE IN METER (M) UNLESS OTHERWISE SPECIFIED.
 3. GAZAK STONE SHOULD HAVE 15MM GROUT IN BETWEEN EACH TILE.
 4. GAZAK STONE WHEN USED IN ELEVATION SHOULD BE POLISHED.

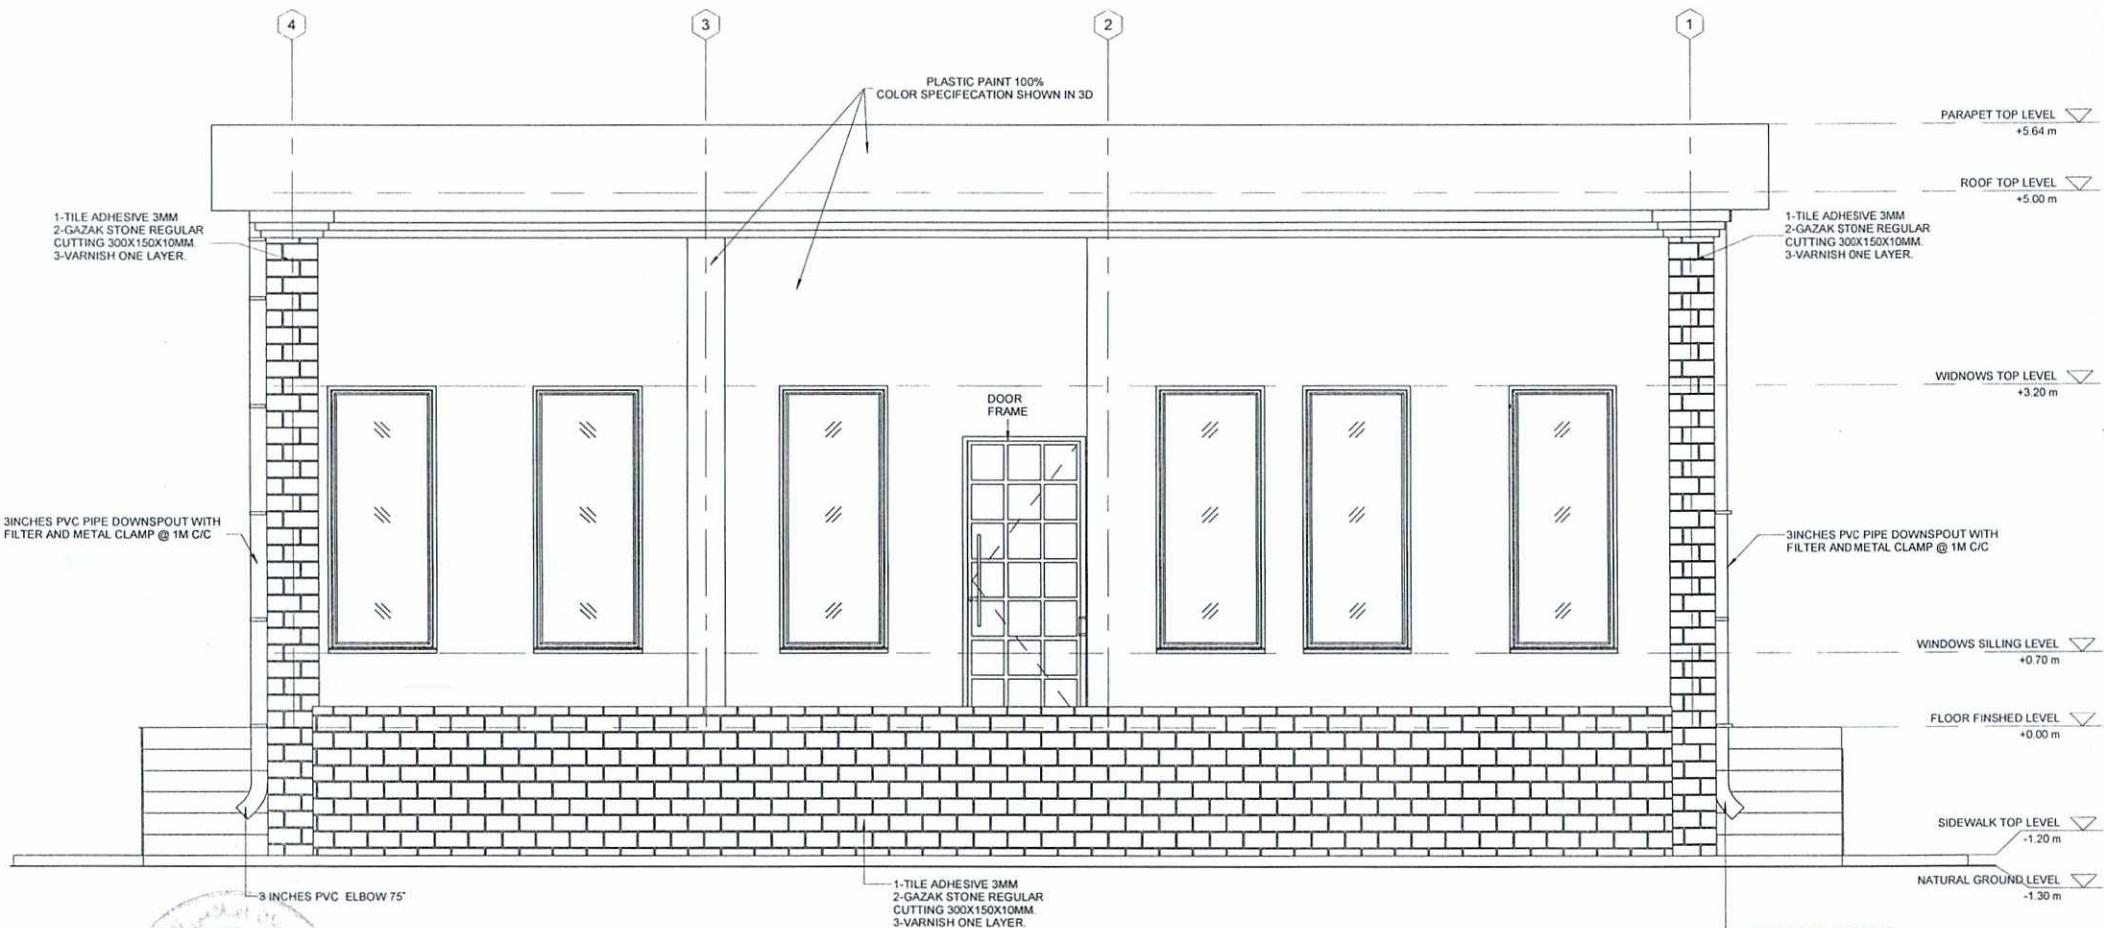

1 ELAVATION C-C
A-202 Ref: A-101 Scale: 1 : 50

0 250 500 1000 1500 2000 2500
GRAPHIC SCALE: 1:50 (mm)



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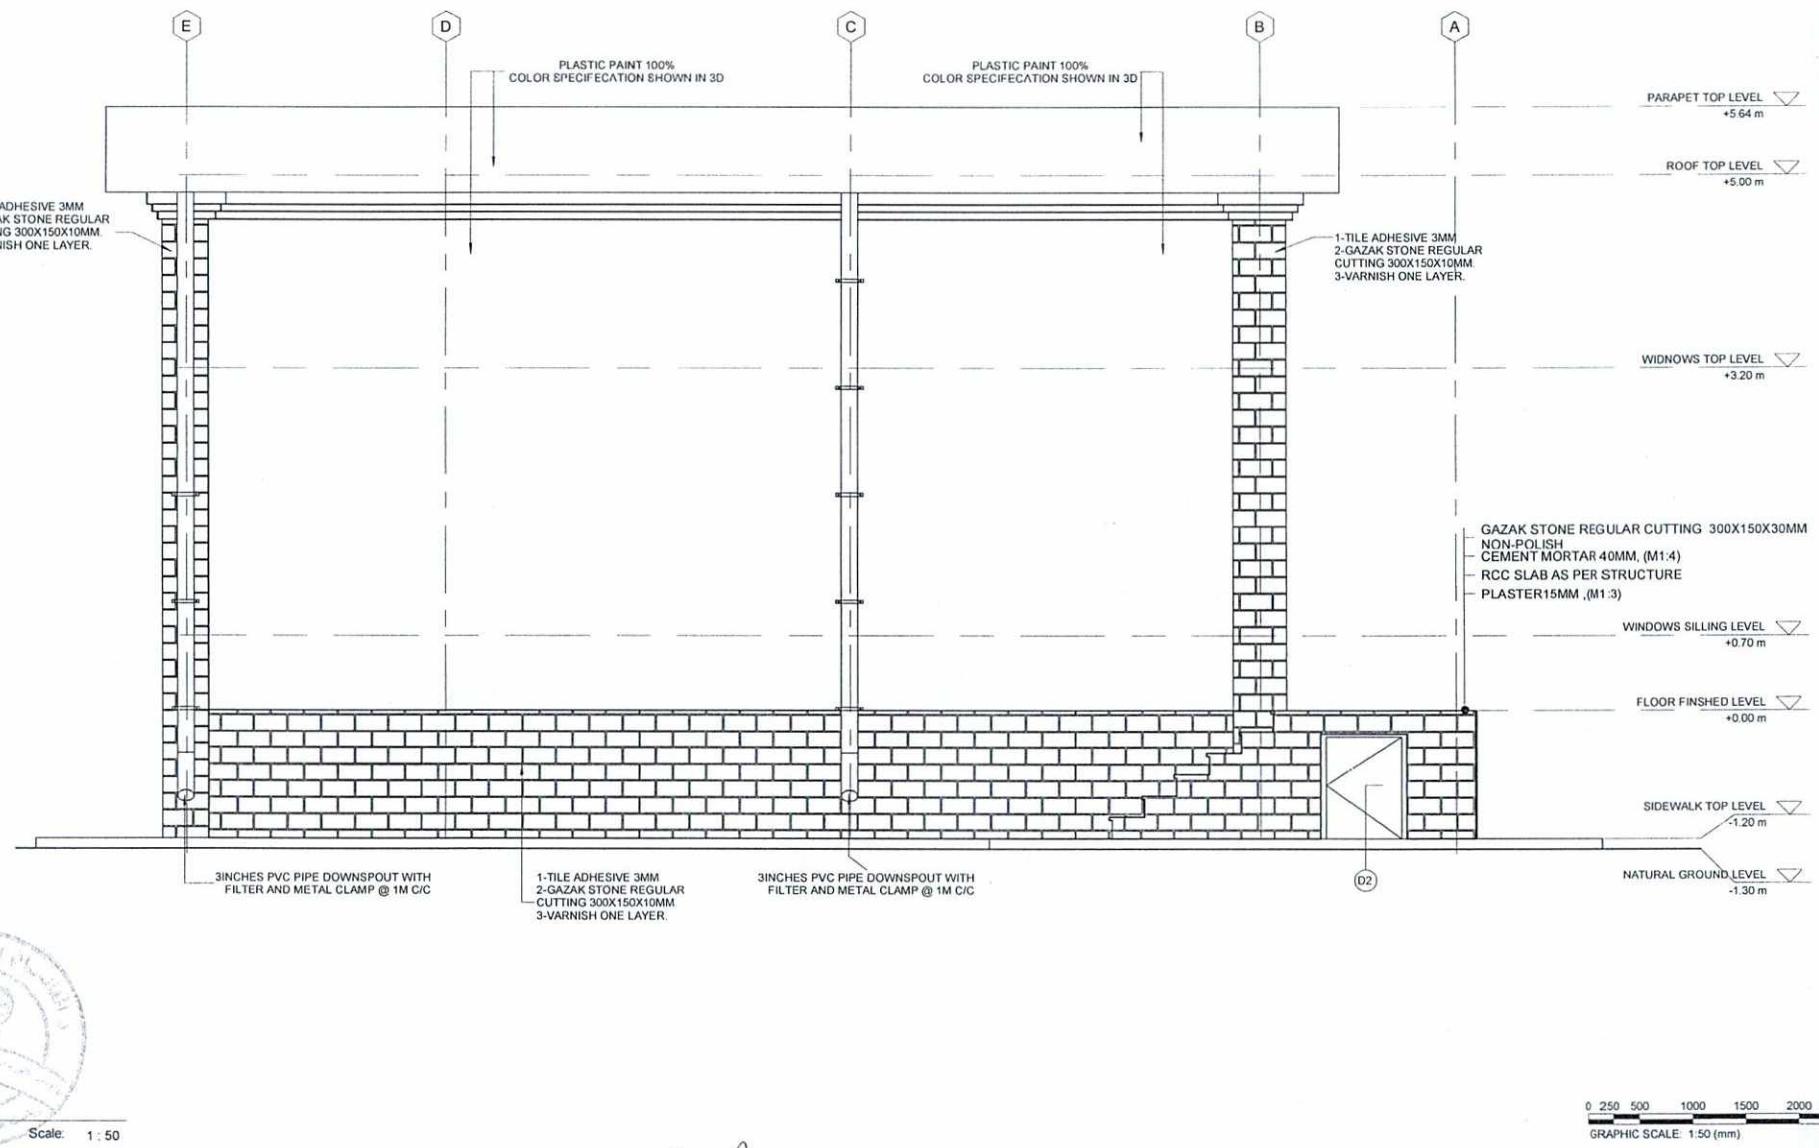
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Drawn by:	Obaidullah Wardak	(01)	For Construction	1403/04/15
Checked By Head of Department:	Abdul Basir Rahimi			
Approved by Visa Committee:	Pt.D Hashmatullah Almar			

Contract No:	
Contract Date:	
Fiscal Year:	1403/1445
Drawn Code:	SDCBA
Paper Size:	A3
Plot Date:	1403/04/09
Scale:	1 : 50

SERVICES DIRECTORATE COMPLEX BUILDING AOP
KABUL PROVINCE , AFGHANISTAN


POWER PLANT
ELEVATION C-C
Scale: 1 : 50

Sheet Reference Number
A-202




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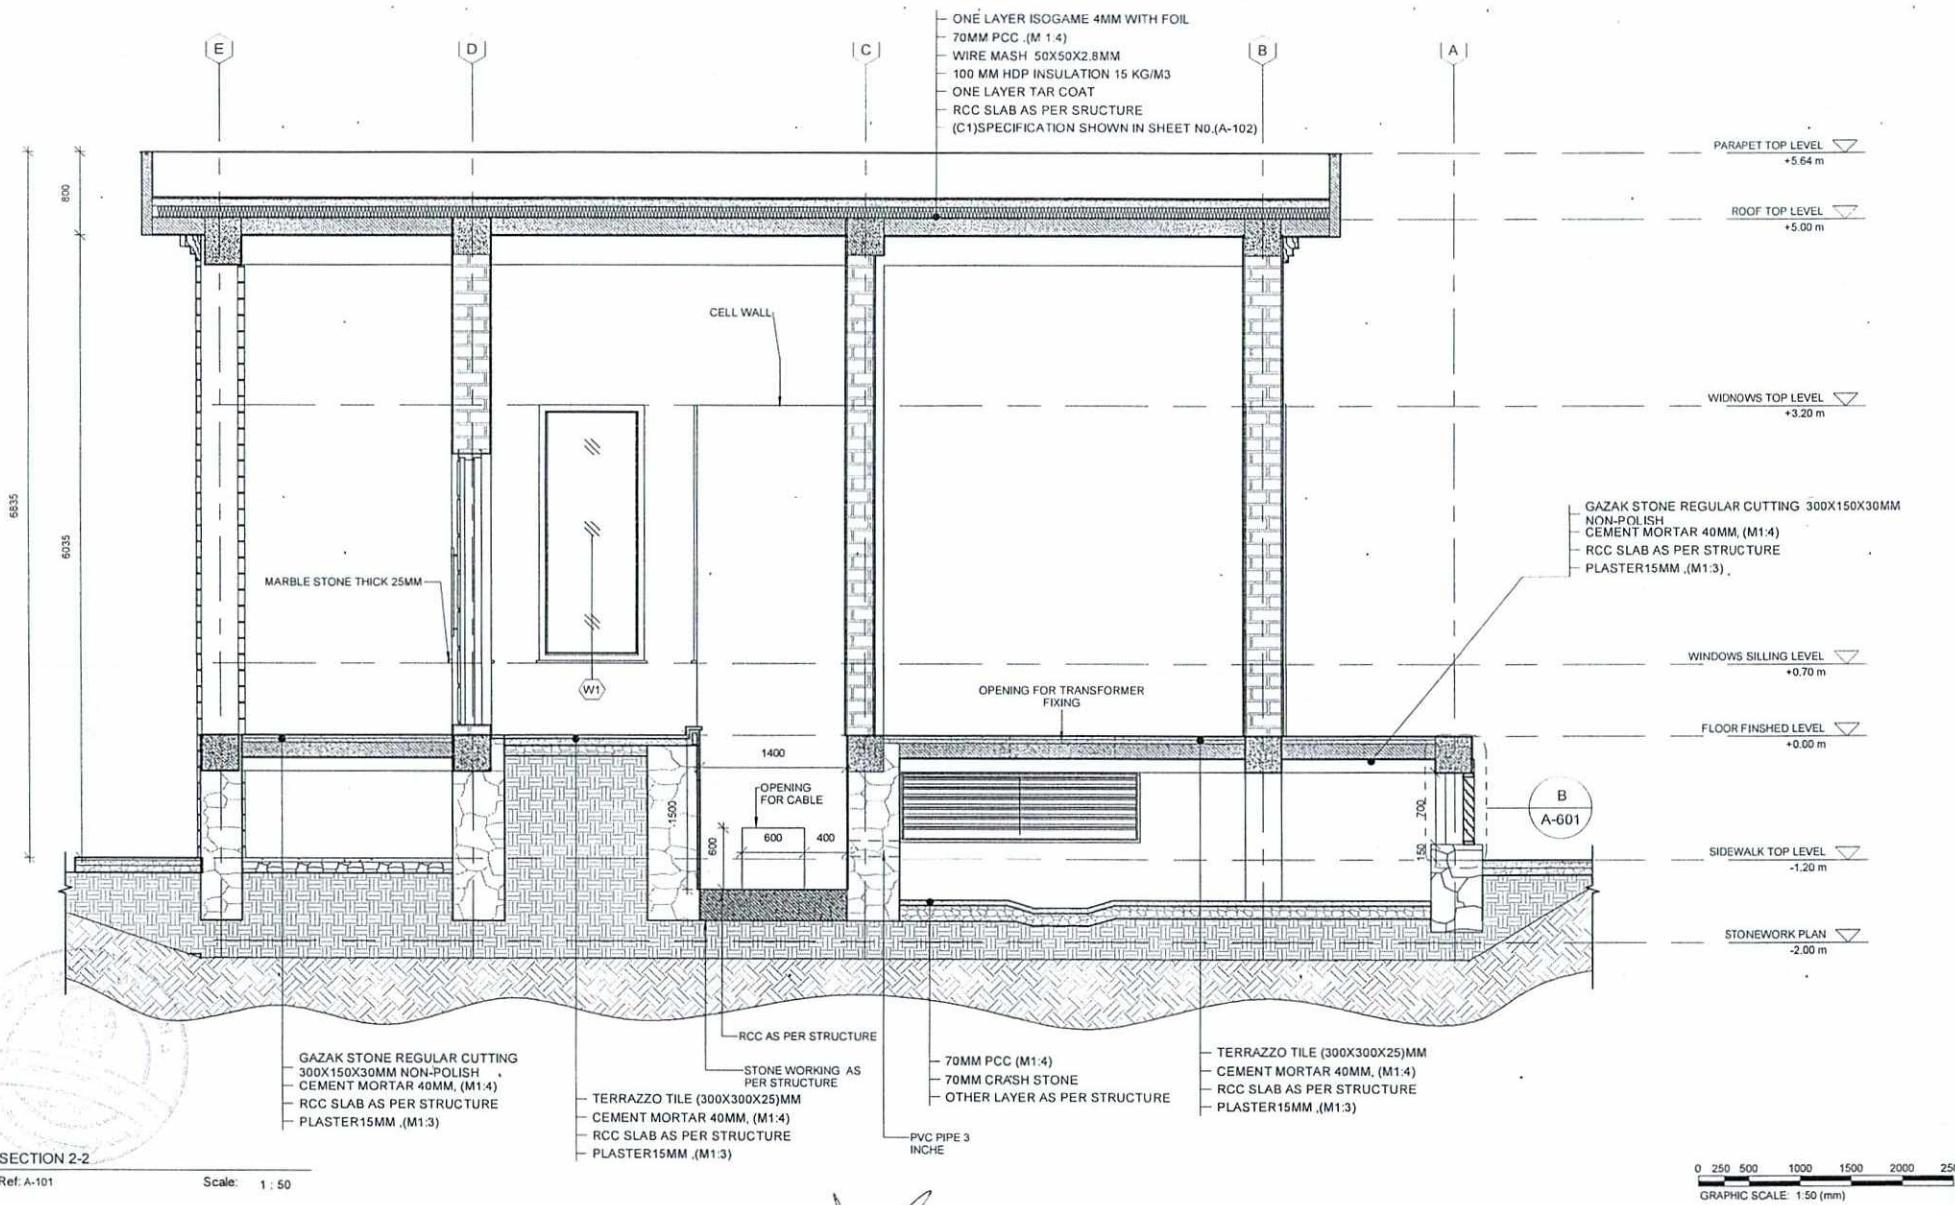
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GRAPHIC SCALE: 1:50 (mm)

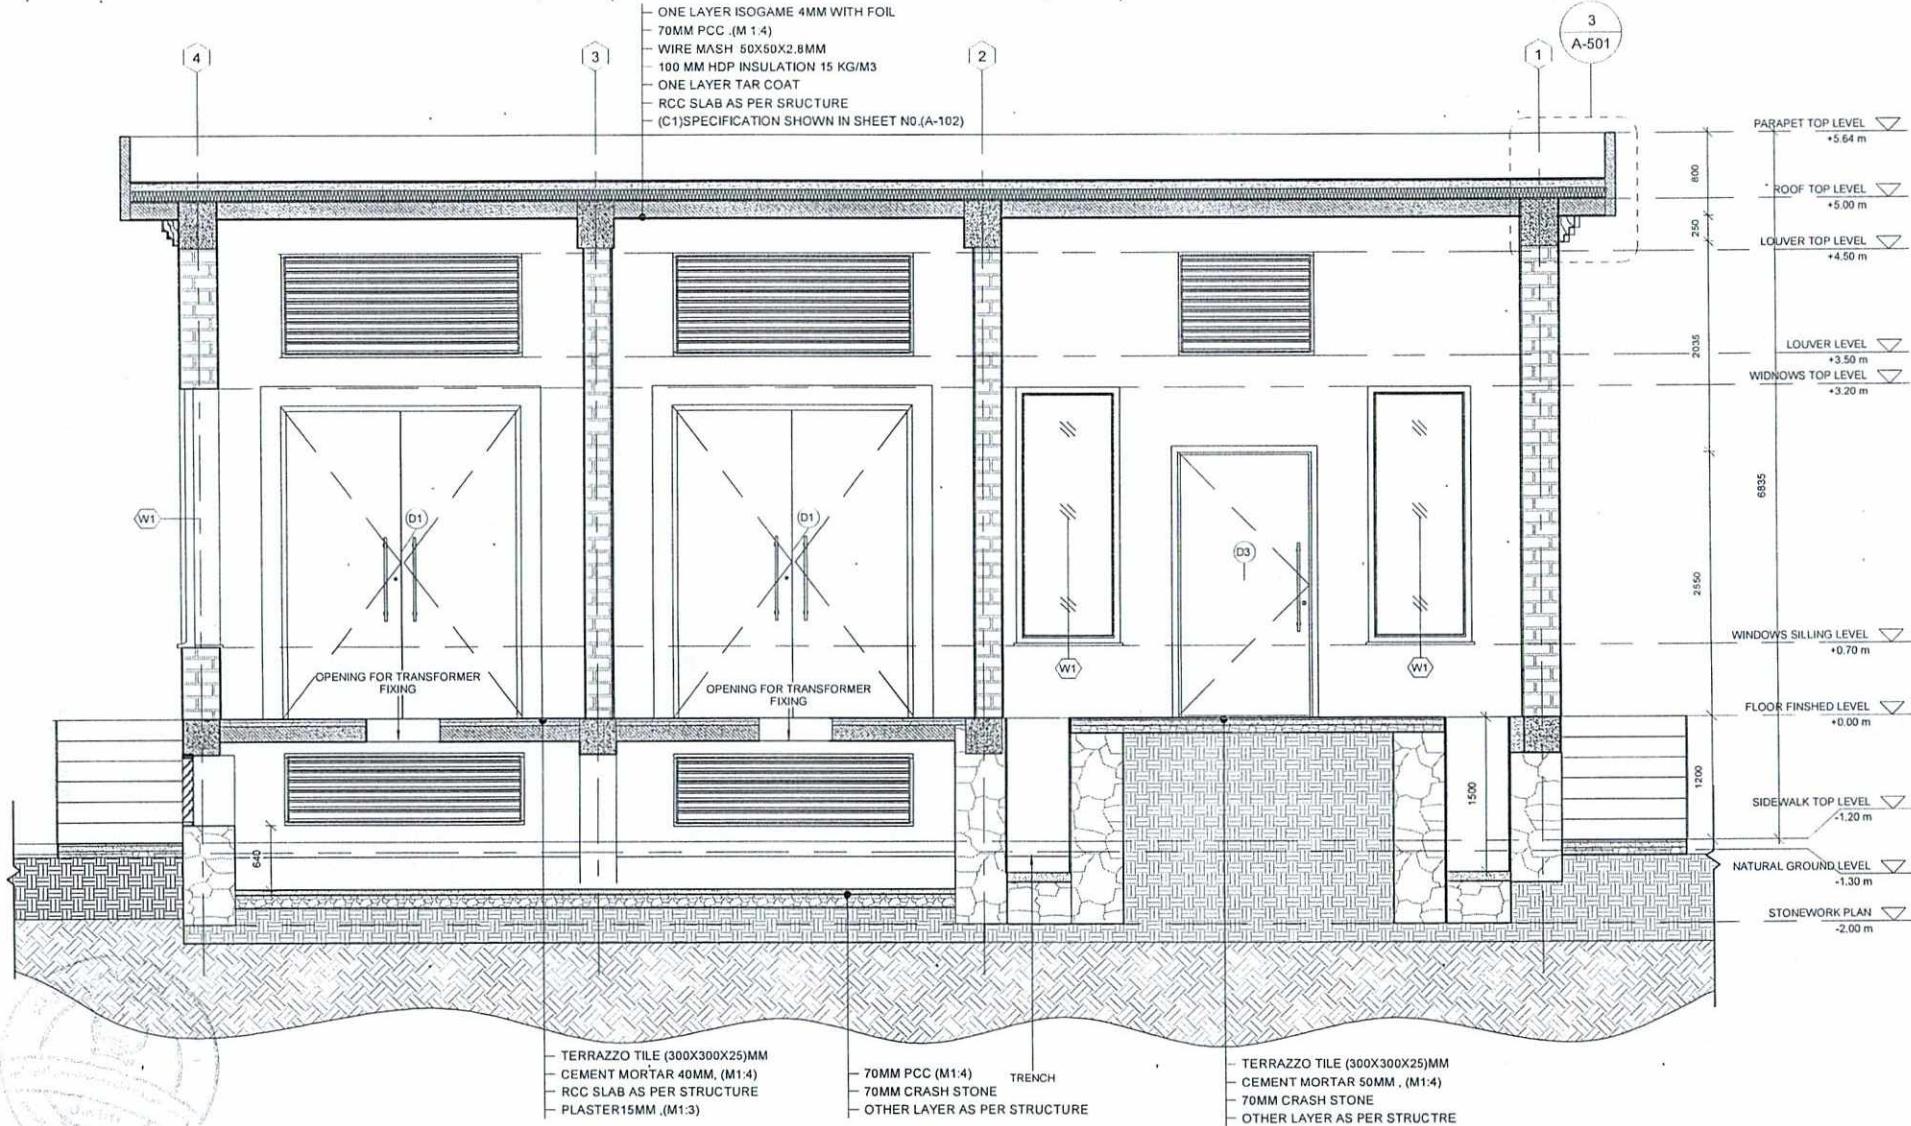

Designed by:	Obaidullah Wardak	No.	Description:	Date:
Drawn by:	Obaidullah Wardak	(01)	For Construction	1403/04/15
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Approved by Visa Committee:	Ph.D Hashmatullah Almar			

SERVICES DIRECTORATE COMPLEX BUILDING AOP
KABUL PROVINCE , AFGHANISTAN
POWER PLANT
SECTION 1-1

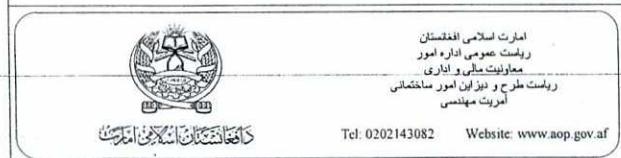Sheet Reference Number
A-301



دانشگان اسلامی امیرکبیر

امارت اسلامی المختلس
ریاست عمومی اداره امور
عماونیت ملی و اداری
ریاست طرح و نیز این امور ساخته ای
امرت مهندسی


Designed by:	Obaidullah Wardak		No.	Submission Description:	Date:
Drawn by:	Obaidullah Wardak		01	For Construction	1403/04/
Checked By Head of Department:	Abdul Basir Rahimi				
Approved by Visa Committee:	Ph.D Hashmatullah Almar				

SERVICES DIRECTORATE COMPLEX BUILDING AOP
KABUL PROVINCE , AFGHANISTAN

POWER PLANT
SECTION 2-2

Sheet
Reference
Number


A-302

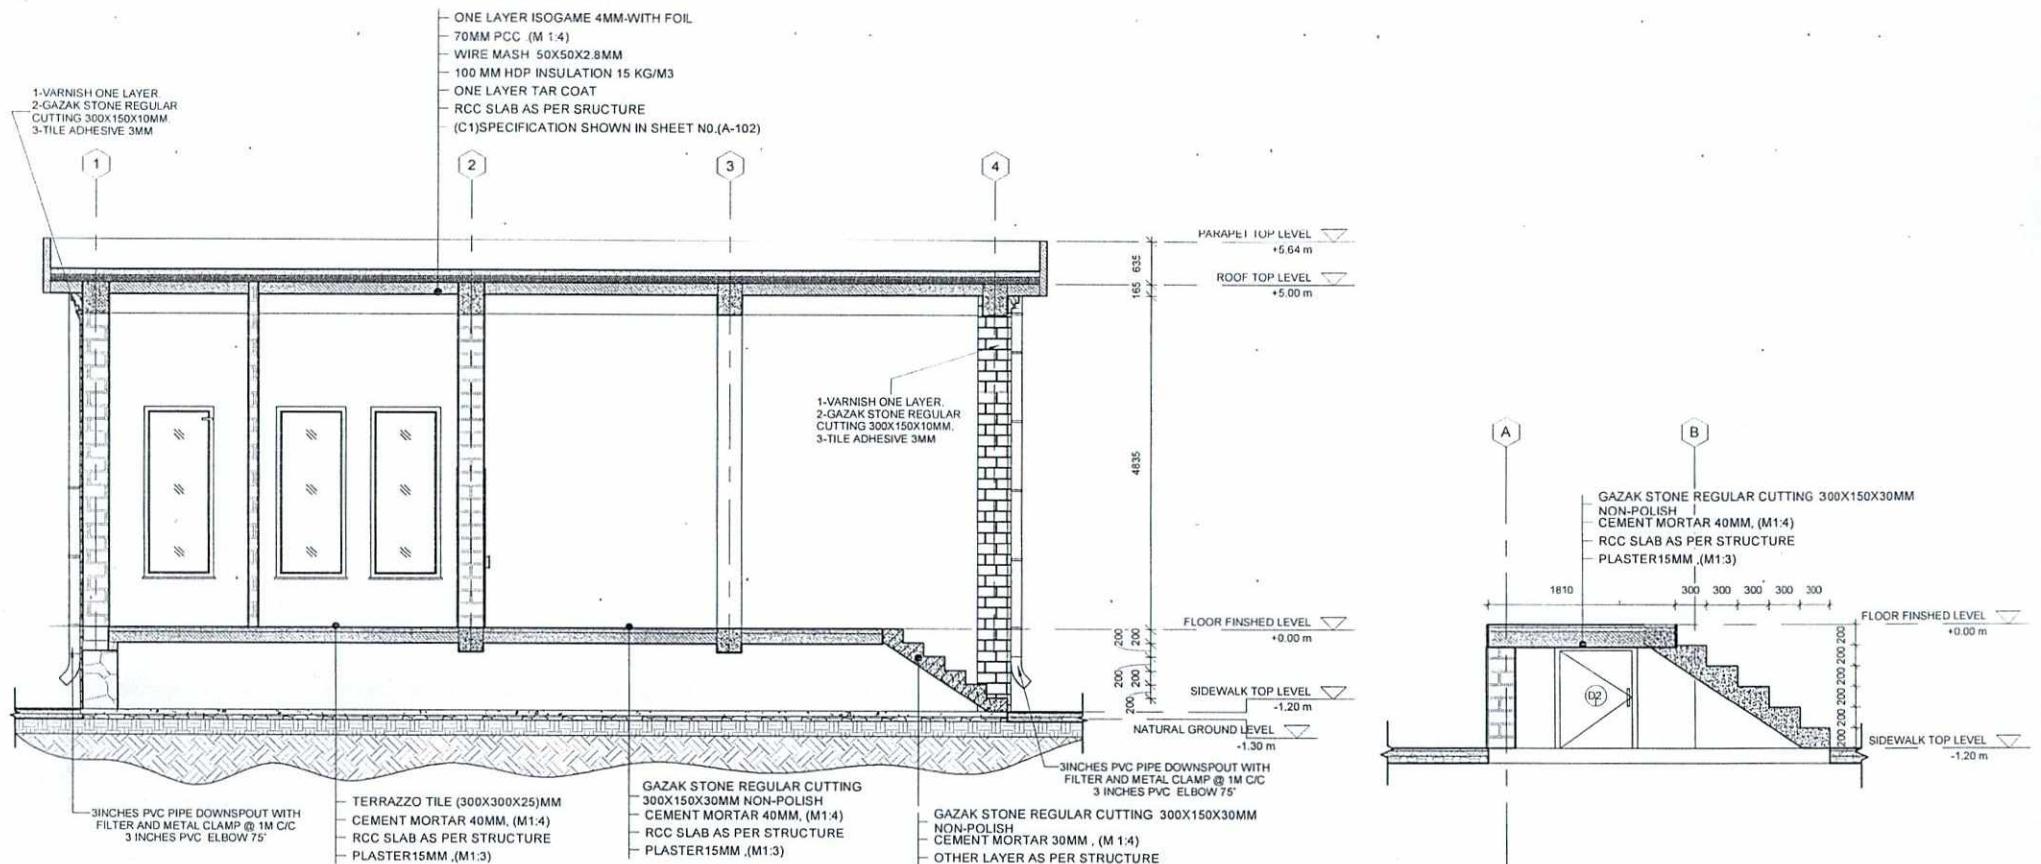

1 SECTION 3-3
A-303 Ref: A-101 Scale: 1 : 75

2 SECTION 4-4
A-303 Ref: A-101 Scale: 1 : 50

0 375 750 1500 2250 3000 3750
GRAPHIC SCALE: 1:75 (mm)

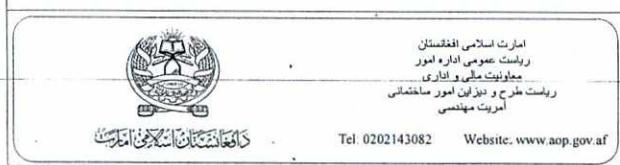


Designed by:	Obaidullah Wardak	No.	Submission Description:	Date
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Scale:	As indicated

SERVICES DIRECTORATE COMPLEX BUILDING AOP
KABUL PROVINCE, AFGHANISTAN

POWER PLANT
SECTION 3-3,AND 4-4


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A-303

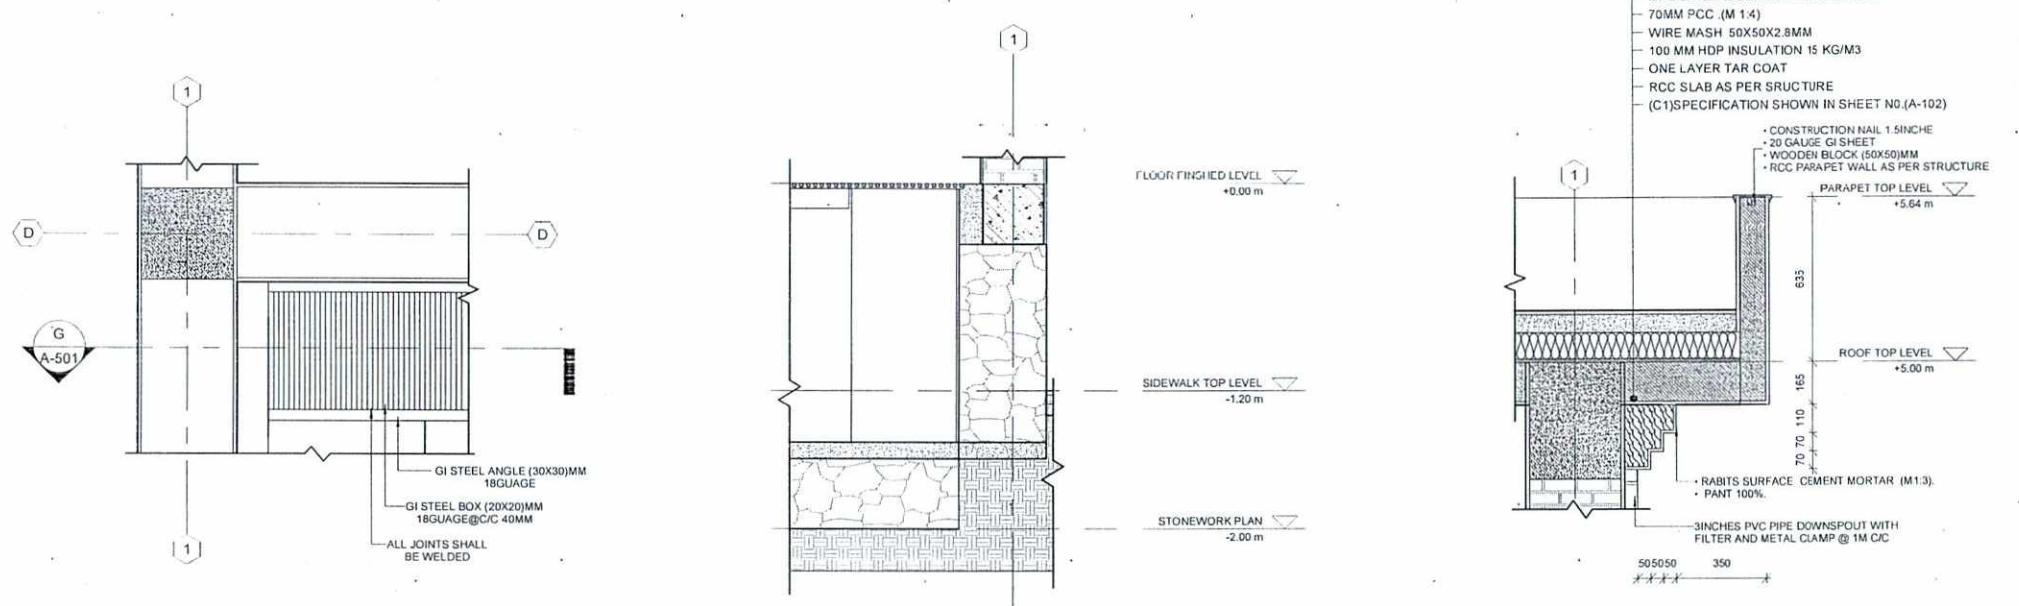


1 GRILL PLAN
A-501 Ref: A-102 Scale: 1:20

2 GRILL SECTION G-G
A-501 Ref: AS PER SHEET Scale: 1:30

4 DETAIL 2-2
A-501 Ref: A-301 Scale: 1:20

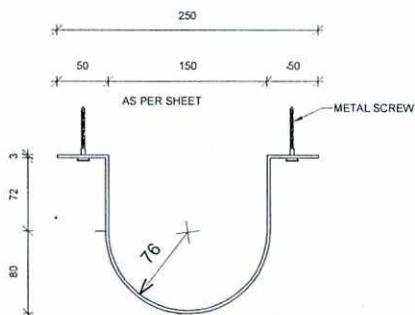

METAL CLAMP
Ref: A-201 Scale: 1:5

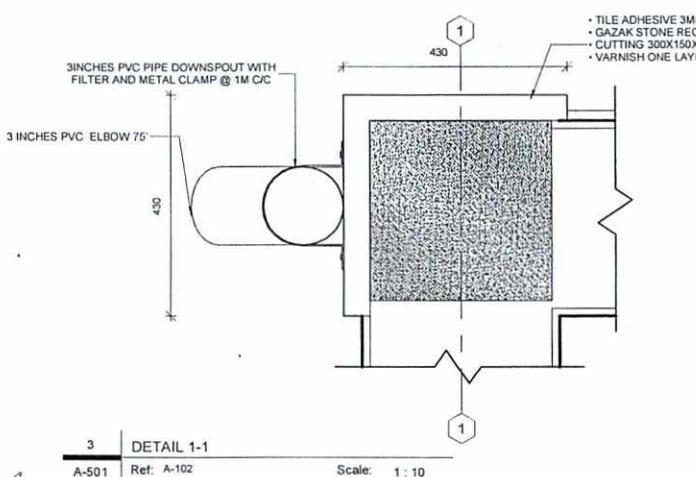

3 DETAIL 1-1
A-501 Ref: A-102 Scale: 1:10



د.ا.پ.ا. دیکٹوریٹ کابل







امارت اسلامی افغانستان
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Checked By Head of Department:	Abdul Basir Rahimi			
Approved by Visa Committee:	Ph.D Hashmatullah Almar			

SERVICES DIRECTORATE COMPLEX BUILDING AOP
KABUL PROVINCE ,AFGHANISTAN
POWER PLANT
GRILL PLAN&SECTION DETAILS, METAL CLAMP DETAIL AND
DETAIL 1-1,2-2

Sheet Reference Number
A-501

GENERAL NOTE:
 1. ALL DIMENSIONS ARE IN MM UNLESS OTHERWISE SPECIFIED
 2. ALL LEVELS ARE IN METER (M) UNLESS OTHERWISE SPECIFIED
 3. ALL JOINTS SHALL BE WELDED
 4. STEEL BOX FINISHING:
 a-ONE LAYER STAINLESS PAINTED HIGH QUALITY.
 b-TWO LAYER OIL PAINTED HIGH QUALITY.

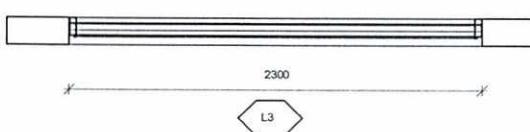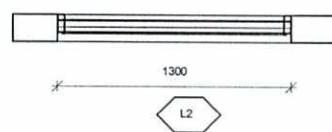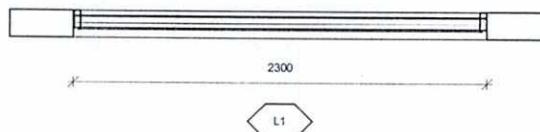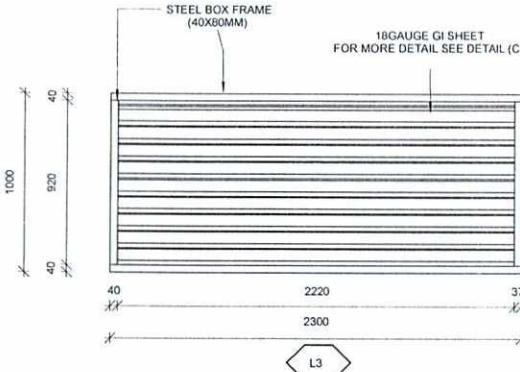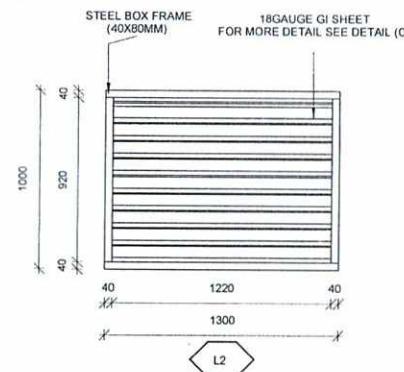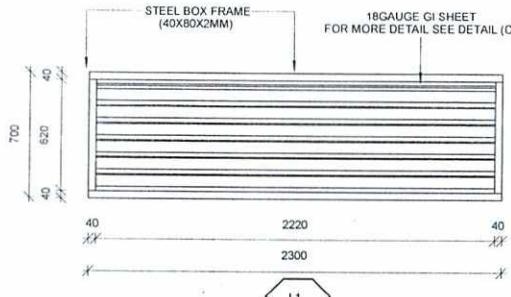

LOUVER SCHEDULE AND SPECIFICATIONS

No	Tag	Dimension		Opening System		Material		
		Width	Height	Type	No. Of Hinges	Count	Frame	Blade
01	L1	2300	700	fixed	4	1	Steel box(80x40x2)MM	18 gauge Gi sheet
02	L2	1300	1000		1	1	Steel box(80x40x2)MM	18 gauge Gi sheet
03	L3	2300	1000	fixed	2	2	Steel box(80x40x2)MM	18 gauge Gi sheet

1 LOUVER PLANS,ELEVATIONS&SCHEDULE

Ref: A-201 Scale: 1 : 30



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Checked By Head of Department:	Abdul Basir Rahimi
Approved by Visa Committee:	Ph.D Hashmatullah Atmar


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(01)	For Construction	1403/04/15

Contract No:	
Contract Date:	
Fiscal Year:	1403/1445
Drawn Code:	SDCBA
Paper Size:	A3
Plot Date:	1403/04/09
Scale:	As Indicated

SERVICES DIRECTORATE COMPLEX BUILDING AOP
 KABUL PROVINCE , AFGHANISTAN


POWER PLANT
 WINDOWS PLAN ,ELEVATION ,SCDEULE&SECTION

Sheet Reference Number
 A-601

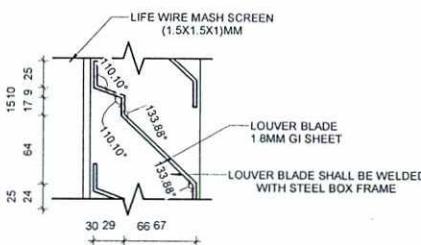

2 LOUVER BLADE DETAIL(C)


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3 BLADE 3D

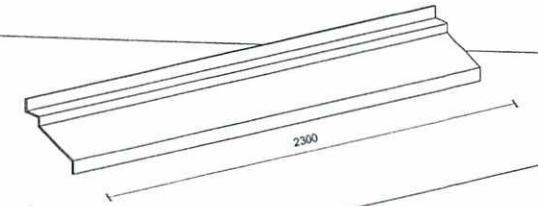
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0 250 500 1000 1500 2000 2500
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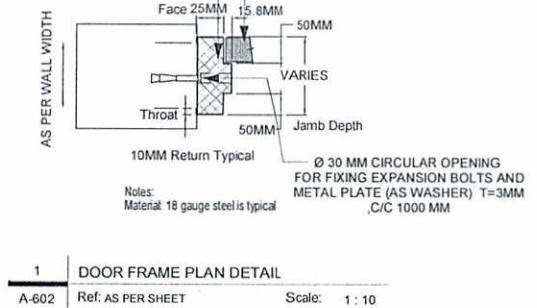


WINDOW (W1) PLAN, ELEVATION, AND SCHEDULE
Ref: A-202 Scale: 1 : 30


Window Schedule & Specification									
No	Tag	Dimensions		Opening System		Material			
		Width	Height	Type	No. Of Hinges	Count	Frame	Glazing	Sill
01	W1	1000	2500	Fixed	12	(7000) PVC	Double Glass 4mm,with 11mm Gap	Gazak Stone 420x1030x30mm	

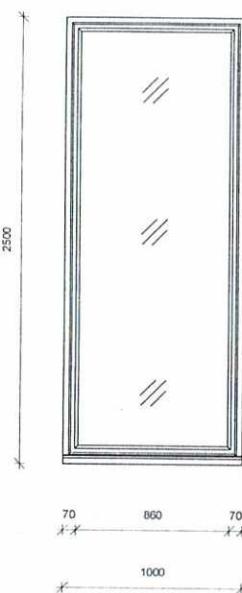

DOOR (D1) PLAN ELEVATION D1
Ref: A-201 Scale: 1 : 30

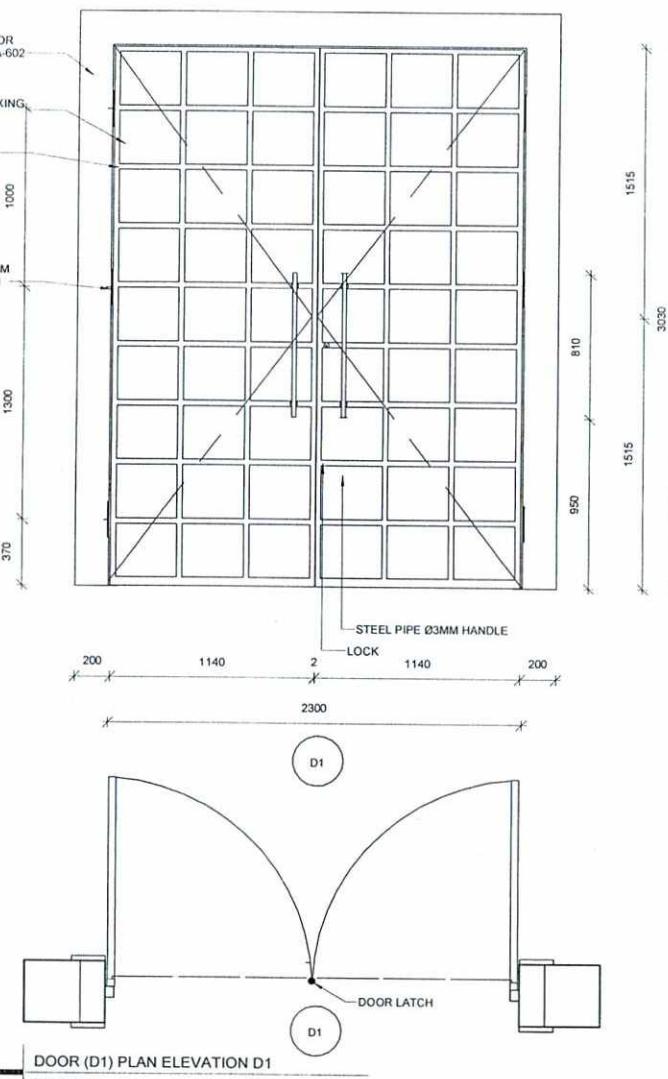

1 DOOR FRAME PLAN DETAIL
A-602 Ref: AS PER SHEET Scale: 1 : 10

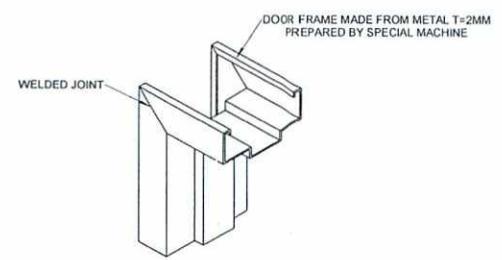

2 DOOR FRAME 3D
A-602 Ref: AS PER SHEET Scale: 1 : 10

DOOR(D1) SCHEDULE									
NO	Type	Mark	DIMENSIONS			OPENING SYSTEM			MATERIAL
			Width	Height	Count	Type	No. OF Hinges	Frame	Panel
01	D1		2300	3030	2	HINGE	6	METAL FRAME 2MM	METAL BAORD 1.5MM



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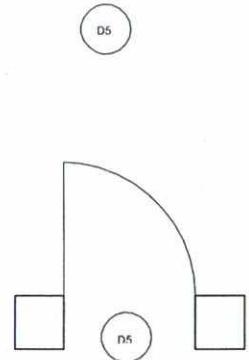
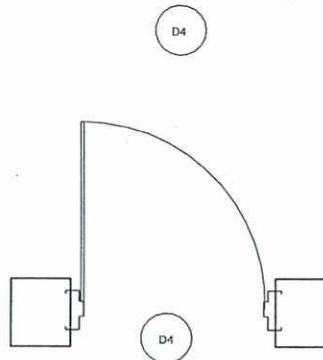
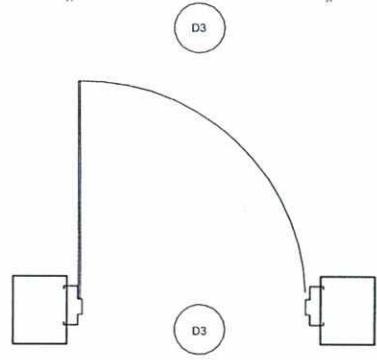
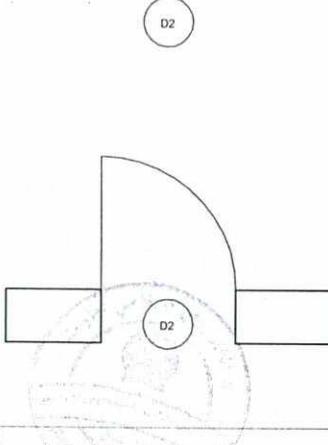
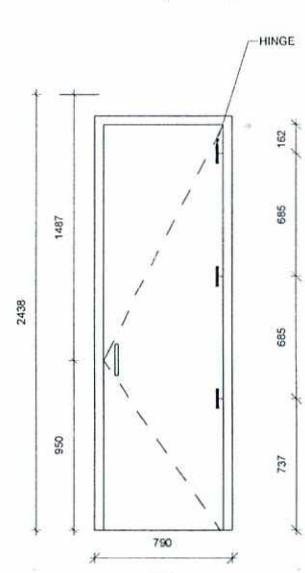
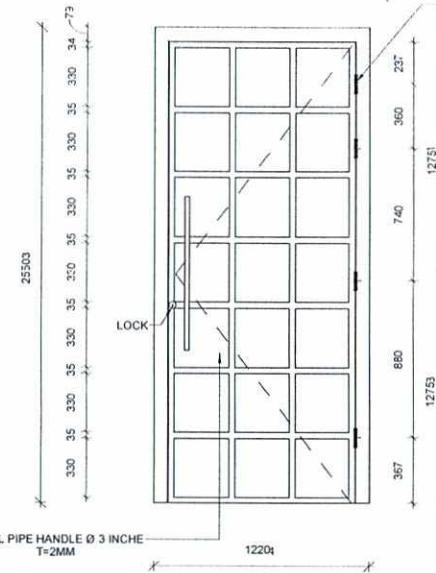
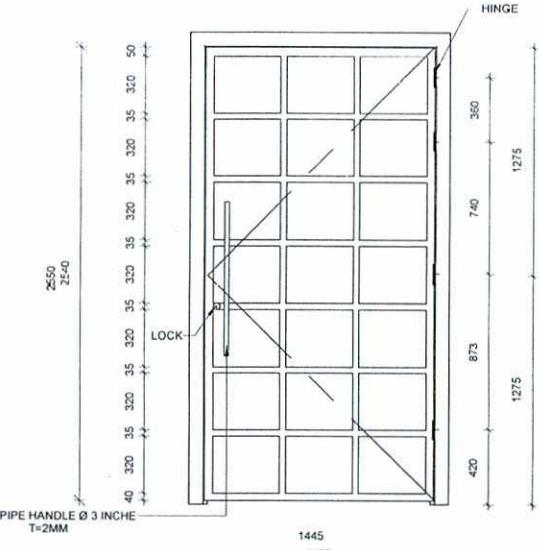
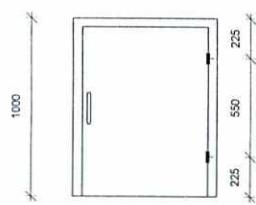
Designed by:	Obaidullah Wardak	No.	Submission Description:	Date
Drawn by:	Obaidullah Wardak	(01)	For Construction	1403/04/15
Checked By Head of Department :	Abdul Basir Rahimi			
Approved by Visa Committee:	Ph.D Hashmatullah Almar			

Contract No:	
Contract Date:	
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Scale:	As indicated

SERVICES DIRECTORATE COMPLEX BUILDING AOP
KABUL PROVINCE, AFGHANISTAN

POWER PLANT
WINDOW(W1) AND DOOR (D1)PLAN,ELEVATION , SCHEDULE
AND FRAME PLAN,3D DETAILS

Sheet Reference Number
A-602



Door Schedule								
No	TAG	DIMENSIONS		Count	OPENING SYSTEM		MATERIAL	
		Width	Height		Type	No. of Hinges	FRAME	PANEL
01	D2	800	1000	3	HINGE	2	METAL FRAME 2MM	METAL BAORD 1.5MM
02	D3	1500	2550	1	HINGE	4	METAL FRAME 2MM	METAL BAORD 1.5MM
03	D4	1220	2550	1	HINGE	4	METAL FRAME 2MM	METAL BAORD 1.5MM
04	D5	750	2300	3	HINGE	3	PVC 8000	PVC

Grand total: 8

DOOR, PLAN ,ELEVATION & SCHUDLE
Ref: A-101 Scale: 1 : 30

0 150 300 600 900 1200 1500
GRAPHIC SCALE: 1:30 (mm)



د

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وزارت مهندسی

Tel: 0202143082 Website: www.aop.gov.af

Designed by:	Obaidullah Wardak	Signature	No.	Submission Description:	Date:
Drawn by:	Obaidullah Wardak		(01)	For Construction	1403/04/15
Checked By Head of Department :	Abdul Basir Rahimi				
Approved by Visa Committee:	Ph.D Hashmatullah Atmar				


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Scale:	1 : 30

SERVICES DIRECTORATE COMPLEX BUILDING AOP
KABUL PROVINCE , AFGHANISTAN

POWER PLANT
DOOR PLAN ,ELEVATION ,SCHEDULE&SECTION

Sheet Reference Number

A-603

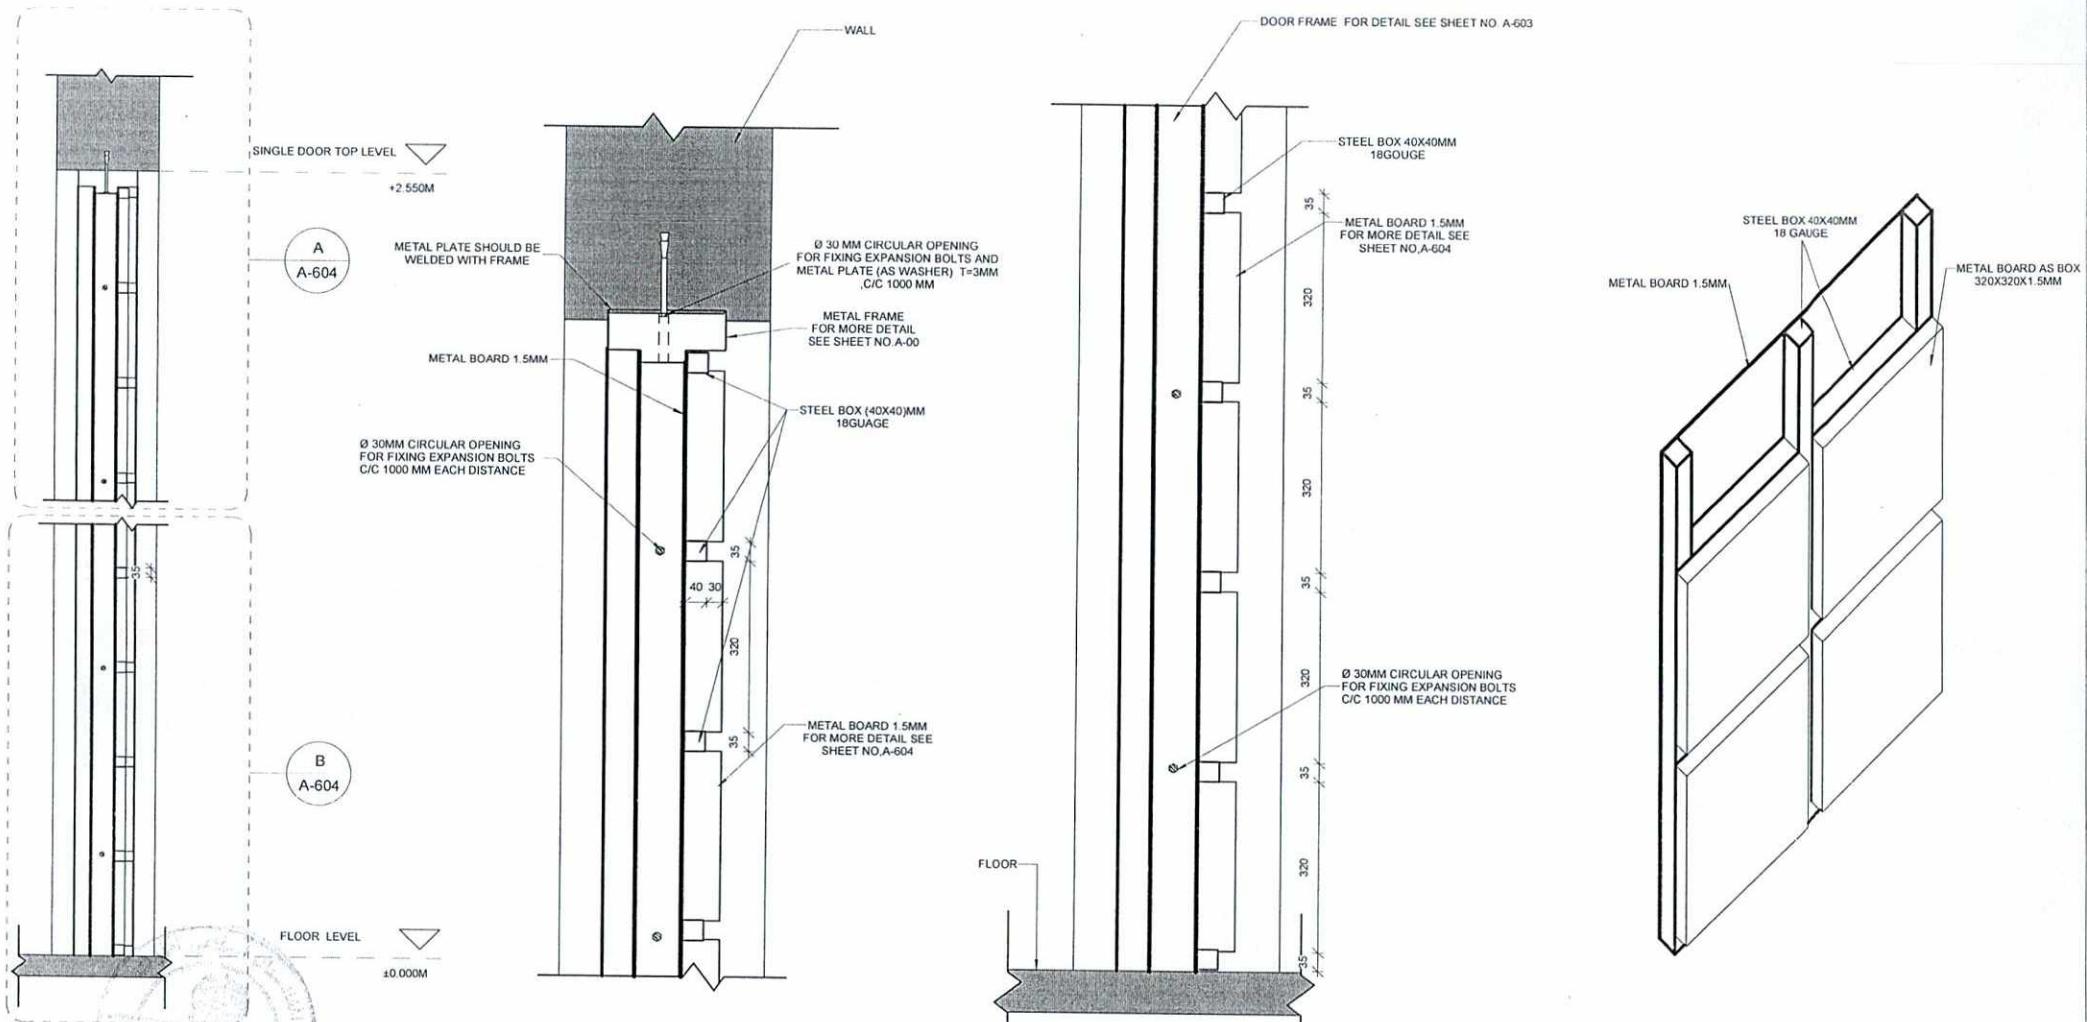

1 DOOR TYPICAL SECTION
A-604 Ref. FOR TYPICAL DOOR Scale: 1 : 20

2 CALLOUT-A
A-604 Ref. AS PER SHEET Scale: 1 : 10

3 CALLOUT-B
A-604 Ref. AS PER SHEET Scale: 1 : 10

4 METAL BOARD DETAIL
A-604 Ref. AS PER SHEET Scale: 1 : 10



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Designed by:	Obaidullah Wardak	No.	Submission Description	Date:
Drawn by:	Obaidullah Wardak	(01)	For Construction	1403/04/15
Checked By Head of Department:	Abdul Basir Rahimi			
Approved by Visa Committee:	Ph.D Hashmatullah Almar			

Contract No.:	
Contract Date:	
Fiscal Year:	1403/1445
Drawn Code:	SDCBA
Paper Size:	A3
Plot Date:	1403/04/09
Scale:	As indicated

SERVICES DIRECTORATE COMPLEX BUILDING AOP
KABUL PROVINCE , AFGHANISTAN

POWER PLANT
DOOR TYPICAL SECTION , CALLOUT(A,B) & METAL BOARD
DETAIL

Sheet
Reference
Number

A-604



د افغانستان ریاست جمهوری

امارت اسلامی افغانستان

معاونیت مالی و اداری

ریاست طرح و دیزاین امور ساختمانی


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تعمیر کمپلکس ریاست خدمات
برج برق ساحه ۵
کابل-افغانستان



SHEET INDEX

SHEET No.	FILE NAME	DRAWING TITLES	SCALE	SHEET No.	FILE NAME	DRAWING TITLES	SCALE
		STRUCTURAL					
	COVER	COVER	NTS				
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S-001		STRUCTURAL ABBREVIATION	NTS				
S-002		STRUCTURAL GENERAL	NTS				
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S-102		FOUNDATION AND COLUMN LAYOUT PLAN	1:40				
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S-104		TOP(X-DIRECTION)REINFORCEMENT FOUNDATION PLAN	1:40				
S-105		BOT(Y-DIRECTION)REINFORCEMENT FOUNDATION PLAN	1:40				
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S-201		BEAM ELEVATION AND SECTION	1:40				
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S-203		GRADE BEAM ELEVATION	1:40				
S-301		EXCAVATION SECTION	1:30				
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S-303		FOUNDATION SECTION	1:20				
S-304		FOUNDATION SECTION	1:20				
S-305		COLUMN SECTION	1:20				

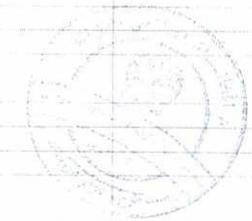

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Designed by:	Mutasim Bilal Jarar
Drawn by:	Mutasim Bilal Jarar
Checked By Head of Department:	Noorulhuda Haqani
Approved by Visa Committee:	M.Musa Essazai

No.	Submission Description:	Date:
(01)	For Construction	1403/04/15
(02)		
(03)		
(04)		
(05)		

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SERVICES DIRECTORATE COMPLEX BUILDING
AOP
KABUL PROVINCE, AFGHANISTAN

POWER PLANT BUILDING

SHEET INDEX

Sheet Reference Number

G-001

STRUCTURAL ABBREVIATIONS:

ACI	AMERICAN CONCRETE INSTITUTE	INV	INVERT
AISC	AMERICAN INSTITUTE OF STEEL CONSTRUCTION	JT	JOINT
ADDL	ADDITIONAL	Kg	KILOGRAM
AL	ALUMINUM	Km	KILOMETER
ALT	ALTERNATE	kPa	KILOPASCAL
APPROX	APPROXIMATELY	Lf	ANGLE (# INDICATES SIZE)
ASTM	AMERICAN SOCIETY FOR TESTING AND MATERIALS	LONG	LONGITUDINAL
		LLV	LONG LEG VERTICAL
ARCH	ARCHITECTURAL	M	METER
B	BOTTOM BAR	MAX	MAXIMUM
BLDG	BUILDING	MBM	METAL BUILDING
BOTT	BOTTOM	MECH	MECHANICAL
C	CENTER LINE	MFG	MANUFACTURER
C/C	CENTER TO CENTER	MID	MIDDLE
CFMRF	COLD FORM METAL ROOF FRAME	MIN	MINIMUM
CFMF	COLD FORM METAL FRAME	MISC	MISCELLANEOUS
CFS	COLD FORMED STEEL	MM	MILLIMETER
CIP	CAST-IN-PLACE	MPa	MEGAPASCAL
CIPL	CAST-IN-PLACE LINTEL	MTL	METAL
CJ	CONTROL JOINT	MWFRS	MAIN WIND FORCE
CLR	CLEAR	RESISTING SYSTEM	
CMU	CONCRETE MASONRY UNIT	N	NEWTON
COEFF	COEFFICIENT	N	NORTH
COL	COLUMN	N/A	NOT APPLICABLE
CONC	CONCRETE	Ø	SYMBOL FOR REBAR SIZE
CONT	CONTINUOUS	NTS	NOT TO SCALE
CONN	CONNECTION	O.C.	ON CENTER
COORD	COORDINATE	OPNG	OPENING
CSJ	CONSTRUCTION JOINT	R	OR PL PLATE
CTJ	CONTROL JOINT	P.C	PLAIN CONCRETE
DIA	DIAMETER	PL	PLATE
DIAG	DIAGONAL	P.L	PAPARET LEVEL
DIM	DIMENSION	PRE-ENG	PRE-ENGINEERED
DN	DOWN	RB	RING BEAM
DTL	DETAIL	REINF	REINFORCED
DWG	DRAWING	REQ'D	REQUIRED
DWL	DOWEL	SIM	SIMILAR
EA	EACH	SPECS	SPECIFICATIONS
EF	EACH FACE	STD	STANDARD
ELEC	ELECTRICAL	STRUCT	STRUCTURAL
ELEV	ELEVATION	SW	SHEAR WALL
EMBED	EMBEDMENT	S.O.G	SLAB ON GRADE
EQUIV	EQUIVALENT	T	TOP BAR
ETC	ET CETERA	T/	TOP OF
EW	EACH WAY	T/ELEV	TOP ELEVATION
EXP	EXPANSION	T&B	TOP AND BOTTOM
EXT	EXTERIOR	THK	THICK
F.G.L	FINISH GRADE LEVEL	TYP	TYPICAL
FTG	FOOTING	UFC	UNIFIED FACILITIES
GA	GAUGE	CRITERIA	
HORIZ	HORIZONTAL	UNO	UNLESS OTHERWISE
HRS	HOURS	UON	UNLESS OTHERWISE NOTED
IBC	INTERNATIONAL BUILDING CODE	VERT	VERTICAL
INFO	INFORMATION	W	WIDTH
INT	INTERIOR	W/	WITH

STRUCTURAL DESIGN CRITERIA

- 1- DESIGN AND CONSTRUCTION ARE IN ACCORDANCE WITH:
BUILDING CODE REQUIREMENTS FOR STRUCTURAL CONCRETE, ACI 318M-19
BUILDING CODE: IBC-2012
DESIGN LOADS FOR BUILDINGS AND OTHER STRUCTURES: ASCE-7, 2016
STEEL CONSTRUCTION MANUAL, AISC 360-16
POST TENSION MANUAL, PTI, 2006
AFGHANISTAN BUILDING CODE 2012
- 2- UNLESS NOTED OTHERWISE, STRUCTURAL MEMBERS ARE DESIGNED TO RESIST THE FOLLOWING LOADS:
- a) SUPERIMPOSED LOAD:
 - DEAD LOADS
 - FINISHES (FOR RAISED FLOOR) - 2.00 KN/m² (TO BE CONFIRMED BY FINISHES (FOR MAX. 10 Cm FLOOR FINISH) - 2.00 KN/m² CALCULATION)
 - FINISHES (FOR MAX. 20 Cm FLOOR FINISH) - 4.00 KN/m²
 - SERVICES - 0.50 KN/m²
 - PARTITION (FOR OFFICES AREAS) - 2.00 KN/m²
 - PARTITION (FOR WET AREAS) - 4.00 KN/m² (TO BE CONFIRMED BY ROOF (WATERPROOFING + SCREED) - 5.00 KN/m² CALCULATION)
 - LIVE LOADS
 - OFFICES - 2.50 KN/m²
 - PUBLIC ASSEMBLY AREAS - 5.00 KN/m²
 - PRAYER HALLS - 5.00 KN/m²
 - PARKING - 3.00 KN/m²
 - RAMPS - 5.00 KN/m²
 - STAIRS & 1ST FLOOR CORRIDORS - 5.00 KN/m²
 - LIGHT STORAGE - 6.00 KN/m²
 - OPERATING ROOMS, LABORATORIES - 3.00 KN/m²
 - CORRIDORS ABOVE-FIRST FLOOR - 4.00 KN/m²
 - MECHANICAL ROOMS - 7.50 KN/m² (TO BE CONFIRMED FROM MECH.)
- b) ENVIRONMENTAL LOADS:
 - WIND LOADS
 - WIND PRESSURE LOADS CALCULATED AS PER ASCE-7-2010 - IBC 2012 & AFGHANISTAN CODE 2012 WITH FOLLOWING PARAMETERS:
 - BASIC WIND SPEED (3 SEC. GUST) & (MRI=50 YEARS) - 41m/s
 - WIND SPEED 3 SECOND GUST (MRI=1700 YEAR) - 53m/s
 - IMPORTANCE FACTOR=1.0
 - BUILDING AND STRUCTURAL CLASSIFICATION CATEGORY -
 - EXPOSURE CATEGORY -
 - TOPOGRAPHIC FACTOR KZT -
 - SEISMIC LOADS
 - EARTHQUAKE DESIGN DATA PER ASCE-7-2010, IBC 2012 & AFGHANISTAN CODE 2012 WITH FOLLOWING PARAMETERS :
 - OCCUPANCY CATEGORY - II
 - SEISMIC IMPORTANCE FACTOR - 1
 - SITE CLASS - D
 - MAPPED SPECTRAL RESPONSE ACCELERATION - Ss=1.13
 - MAPPED SPECTRAL RESPONSE ACCELERATION - S1=0.53
 - SPECTRAL RESPONSE COEFFICIENT - SDS=0.7895
 - SPECTRAL RESPONSE COEFFICIENT - SD1=0.6254
 - SEISMIC DESIGN CATEGORY - D
 - RESPONSE MODIFICATION FACTOR - R=8
 - BASIC SEISMIC RESISTING SYSTEM IS SPECIAL REINFORCED CONCRETE FRAMES
 - ANALYSIS PROCEDURE: DYNAMIC ANALYSIS
- THERMAL LOADS

A-GENERAL NOTES

- 1- THIS PROJECT HAS BEEN DESIGNED FOR THE WEIGHTS AND MATERIALS INDICATED ON THE SHEETS AND FOR THE LIVE LOADS INDICATED IN THE DESIGN DATA. IT IS THE CONTRACTOR'S RESPONSIBILITY TO DETERMINE ALLOWABLE CONSTRUCTION LOADS AND TO PROVIDE PROPER DESIGN AND CONSTRUCTION OF FALSEWORK, FORMWORK, STAGING, BRACING, SHEETING AND SHORING, ETC.
- 2- COORDINATE THESE SHEETS WITH THE ARCHITECTURAL, MECHANICAL, ELECTRICAL, PLUMBING, AND CIVIL SHEETS. ALL DIMENSIONS SHOWN ON THE SHEETS ARE MILLIMETERS UNLESS NOTED OTHERWISE.
- 3- THE CONTRACTOR SHALL VERIFY AND COORDINATE ALL FLOOR AND ROOF OPENING SIZES AND LOCATIONS, EQUIPMENT PAD SIZES AND LOCATIONS, ANCHOR BOLT LAYOUTS, ETC WITH EQUIPMENT SELECTED. THE CONTRACTOR SHALL MAKE ANY REQUIRED MODIFICATIONS AT NO ADDITIONAL COST.
- 4- THE CONTRACTOR SHALL REFER TO THE ARCHITECTURAL, MECHANICAL, ELECTRICAL AND PLUMBING SHEETS FOR SLEEVES, CURBS, INSERTS OR OPENINGS, ETC. NOT HEREIN INDICATED.
- 5- SLAB OPENINGS SMALLER THAN 250mm DIA TO BE CORE DRILLED IN FIELD UON. SEE MECHANICAL, ELECTRICAL AND PLUMBING SHEETS FOR LOCATIONS OF THESE OPENINGS.
- 6- WORK NOT INCLUDED ON THE SHEETS BUT IMPLIED TO BE SIMILAR TO THAT SHOWN AT CORRESPONDING PLACES ELSEWHERE ON THE SHEETS SHALL BE REPEATED.
- 7- IN CASE OF CONFLICT BETWEEN THE NOTES, DETAILS AND SPECIFICATIONS THE MOST RIGID REQUIREMENTS SHALL GOVERN.
- 8- SEE ARCHITECTURAL SHEETS FOR LOCATIONS OF BRICK WALLS AND DRYWALL NON-LOAD BEARING PARTITIONS.
- 9- COORDINATE FINISHED FLOOR DATUM ELEVATION 0.0m WITH THE CIVIL SHEETS.

C-REINFORCED CONCRETE :

- 1- ALL CONCRETE SHALL BE NORMAL WEIGHT (N.W) AND SHALL HAVE A 28 DAY COMPRESSIVE STRENGTH AS DESCRIBED IN DETAILS OF COLUMNS, WALL, BEAMS, SLABS AND FOUNDATION
- 2- NO CALCIUM CHLORIDE SHALL BE USED IN ANY CONCRETE.
- 3- MIXING, TRANSPORTING AND PLACING OF CONCRETE SHALL CONFORM TO ACI 301M-05.
- 4- ALL CONCRETE WORK SHALL CONFORM TO THE REQUIREMENTS OF THE AMERICAN CONCRETE INSTITUTE (ACI) 318 MANUAL (metric), "BUILDING CODE REQUIREMENTS FOR REINFORCED CONCRETE", AND REQUIREMENTS OUTLINED IN THE CONTRACT SPECIFICATIONS. WHEN THERE IS A CONFLICT BETWEEN ACI AND THE SPECIFICATIONS, THE MORE STRINGENT SHALL GOVERN.
- 5- CHAMFER ALL EXPOSED EXTERNAL CORNERS OF CONCRETE WITH 20mm x45 DEGREE CHAMFER UON.
- 6- CONCRETE REINFORCEMENT BARS SHALL CONFORM TO ASTM A615M-96a, GRADE 420 MPa, REINFORCING BARS SHALL NOT BE TACK WELDED, WELDED, HEATED OR CUT, UNLESS INDICATED ON THE CONTRACT DOCUMENTS. ALL LAP SPLICES SHALL BE CLASS "B" UON.
- 7- HORIZONTAL FOOTING AND HORIZONTAL WALL REINFORCEMENT SHALL BE CONTINUOUS AND SHALL HAVE 90 DEGREE BENDS AND EXTENSIONS, OR CORNER BARS OF EQUIVALENT SIZE LAPPED WITH A CLASS B TENSION SPLICE AT CORNERS AND INTERSECTIONS. TOP BAR CRITERIA SHALL APPLY IF 300mm OR MORE OF FRESH CONCRETE IS PLACED BELOW BAR.
- 8- SLABS-ON-GRADE SHALL HAVE CONSTRUCTION JOINTS OR CRACK CONTROL JOINTS AS SHOWN ON THE DRAWINGS. CONSTRUCTION JOINTS CAN BE USED AT CONTROL JOINT LOCATIONS AT CONTRACTOR'S OPTION. SEE SLAB PLANS & JOINT DETAILS FOR ADDITIONAL INFORMATION. FOR AREAS NOT SHOWN ON DWGS, THE MAXIMUM SPACING OF CONSTRUCTION/ CRACK CONTROL JOINTS SHALL BE 300mmx3000mm.
- 9- SEE SPECIFICATIONS FOR ALL WATERPROOFING/DAMPPROOFING REQUIREMENT.
- 10- ALL CONCRETE REINFORCEMENT SHALL BE DETAILED, FABRICATED, LABELED, SUPPORTED, AND SPACED IN FORMS AND SECURED IN PLACE IN ACCORDANCE WITH THE PROCEDURES AND REQUIREMENTS OUTLINED IN THE LATEST EDITION OF THE "BUILDING CODE REQUIREMENTS FOR REINFORCED CONCRETE", ACI 318M, AND THE "MANUAL OF STANDARD PRACTICE FOR DETAILING REINFORCED CONCRETE STRUCTURES", ACI 315M, LATEST EDITION.
- 11- ALL DOWELS SHALL MATCH SIZE AND NUMBER OF MAIN REINFORCING, UNLESS NOTED OTHERWISE ON THE SHEETS.
- 12- ADDITIONAL BARS SHALL BE PROVIDED AROUND ALL FLOOR AND WALL OPENINGS AS SHOWN ON THE SHEETS.
- 13- SEE ARCHITECTURAL SHEETS FOR TYPE AND LOCATION OF ALL FLOOR FINISHES.
- 14- THE CONTRACTOR SHALL COORDINATE ADDITIONAL WALL/SLAB OPENINGS NOT SHOWN ON STRUCTURAL SHEETS. SEE MECHANICAL, ELECTRICAL, PLUMBING AND CIVIL SHEETS.
- 15- UNLESS NOTED OTHERWISE, ALL CURBS SHALL BE REINFORCED WITH AT LEAST #12#12 CONTINUOUS AND #12 AT 300mm O.C. DOWELS TO STRUCTURE BELOW.
- 16- THE SUB-CONTRACTOR SHALL VERIFY ALL OPENINGS, PAD SIZES, AND ANCHOR BOLTS WITH EQUIPMENT SELECTED.
- 17- ALL REINFORCING INDICATED TO BE WELDED SHALL BE IN ACCORDANCE WITH ASTM A706M. "LOW ALLOY STEEL DEFORMED BARS FOR CONCRETE REINFORCEMENT", ANY INSTALLATIONS USING MANUFACTURER'S EQUIPMENT SHALL BE PER MANUFACTURER'S RECOMMENDATIONS.
- 18- PROVIDE CONCRETE POUR STOPS OR FORMED AS REQUIRED FOR INSTALLATION OF ALL CONCRETE WORK.
- 19- REQUIREMENT FOR COLD WEATHER CONCRETING SHALL BE IN ACCORDANCE WITH ACI 306.1-90 BASED ON ACI 318-08 SECTION 5.12
- 20- REQUIREMENT FOR HOT WEATHER CONCRETING SHALL BE IN ACCORDANCE WITH ACI 305R-94 BASED ON ACI 318-08 SECTION 5.12.
- 21- MINIMUM CONCRETE COVER PROTECTION FOR REINFORCEMENT BARS SHALL BE AS LISTED BELOW: (SEE ACI 318-08, SECTION 7.7 FOR CONDITIONS NOT NOTED). DIMENSIONS FOR BAR PLACEMENT GIVEN IN SECTIONS AND DETAILS SHALL SUPERSEDE MINIMUM COVER REQUIREMENTS GIVEN HERE. DIMENSIONS ARE IN mm. PROVIDE STANDARD BAR CHAIRS AND SUPPORT BARS @120mm MAXIMUM AS REQUIRED TO MAINTAIN CONCRETE PROTECTION SPECIFIED.


FOOTINGS (EARTH FORMED)	70
COLUMNS / PIERS (TO TIES)	40
GRADE BEAMS OR SLAB TURNED DOWN EDGES:	
TOP	40
BOTTOM (EARTH FORMED)	70
SIDES (EARTH FORMED)	70
SIDES (BOARD FORMED)	N16 BAR & SMALLER 40 N18 TO N36 BAR 50
ELEVATED BEAMS & SLABS:	
BEAM TIRES & STIRRUPS (NOT EXPOSED TO WEATHER)	40
BEAM TIRES & STIRRUPS (EXPOSED TO WEATHER)	50
FLOOR SLABS (NOT EXPOSED TO WEATHER)	20
FLOOR SLABS (EXPOSED TO WEATHER)	
N18 & LARGER	50
N12 & SMALLER	40
ROOF SLAB BARS	25
SLABS ON GRADE	
NOT EXPOSED TO WEATHER (FROM TOP)	20
EXPOSED TO WEATHER (FROM TOP)	40

UTILITY TUNNEL WALLS, RETAINING WALLS AND SHEAR WALLS.
(NO SURFACES SHALL BE EARTH FORMED)
EARTH SIDE AND FRONT SIDE (EXPOSED TO WEATHER)
N16 BAR AND SMALLER 40

Designed by:	Mutasim Billah Jarar	
Drawn by:	Mutasim Billah Jarar	
Checked By Head of Department:	Noorulhuda Haqani	
Approved by Visa Committee:	M.Musa Essaai	
No.	Submission Description:	Date:
(01)	For Construction	1403/04/15
(02)		
(03)		
(04)		
(05)		
Contract No:		
Contract Date:		
Fiscal Year:	1403/1445	
Drawn Code:	SDCB	
Paper Size:	A3	
Plot Date:	1403/04/09	
Scale:	1:00	

SERVICES DIRECTORATE COMPLEX BUILDING
AOP
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POWER PLANT BUILDING
GENERAL NOTE

Sheet Reference Number
S-001

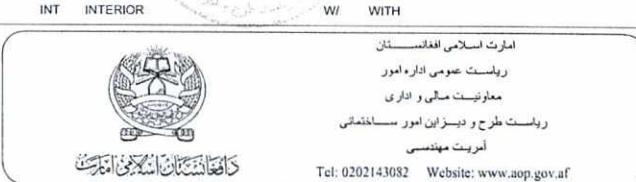

D-DAMP PROOFING AND WATERPROOFING:

- 1-ALL EXTERIOR SURFACES OF SUBSTRUCTURAL CONCRETE SHALL BE PROTECTED BY A DAMP PROOFING COATS REFER TO SPECIFICATIONS.
2-AN INTEGRAL WATERPROOFING ADMIXTURE SHALL BE ADDED TO THE CONCRETE OF THE WATER TANK FLOORS, WALLS AND COLUMNS.
a- SIKA 1 AS MANUFACTURED BY SIKA, LTD, OR
b- R.I.W. CEMENT WATERPROOFING POWDER AS MANUFACTURED BY R.I.W. PROTECTIVE PRODUCTS, LTD; OR
c- AN APPROVED EQUIVALENT.

3-WATER STOPS MUST BE FIXED IN ALL CONSTRUCTION JOINTS IN WATER RETAINING & STRUCTURES WHETHER SHOWN OR NOT SHOWN ON THE DRAWINGS. THE CONTRACTOR SHALL SUBMIT SHOP DRAWINGS REGARDING THE INSTALLATION OF WATER BARS PRIOR TO COMMENCEMENT OF CONCRETING WORKS FOR ENGINEER'S APPROVAL.
4-USE PREFABRICATED ANGLE AND INTERSECTION PIECES FOR PVC WATER-STOP.

5-WATER STOPS SHALL BE SPLICED AND WELDED IN ORDER TO INSURE A CONTINUOUS WATER BARRIER.

6-AN APPROVED POLYTHENE SHEET 1000 GAUGE VAPOUR BARRIER SHALL BE LAID UNDER ALL SLABS ON GRADES.

E-STEEL:

1-STEEL SHAPES AND STEEL PLATES SHALL CONFORM TO ASTM A572 GR.345, DESIGNED TO AISC 360-16 AND AISC GUIDES UNLESS NOTED OTHERWISE.
2-SPICE CONNECTIONS ARE STANDARD AS PER AISC 360-16 STEEL CONSTRUCTION MANUAL.

3-WHERE GROUTED SLEEVES TO FOUNDATION BOLTS ARE USED NO RELIANCE SHOULD BE PLACED ON THE GROUT TO RESIST HORIZONTAL SHEAR. THE CONTRACTOR'S DESIGN SHOULD ENSURE SUCH HORIZONTAL FORCES CAN BE TRANSMITTED BY EITHER BASE FRICTION OR DIRECTLY BY SETTING THE BASE PLATE INTO A SHALLOW POCKET, OR IN THE CASE OF HIGH SHEAR FORCES BY THE PROVISION OF A SHEAR KEY FIXED TO THE UNDERSIDE OF THE BASE PLATE.

4-GROUT UNDER BASE PLATES IS TO BE NON-SHRINK AND HAVE A MINIMUM CHARACTERISTIC STRENGTH AT 28 DAYS OF 60 MPa.

5-SHEAR STUDS SHALL BE 25mm Ø, 100mm LONG HEADED STUDS UNLESS NOTED OTHERWISE AND SHALL CONFIRM TO ASTM A108 WITH A MINIMUM ULTIMATE TENSILE STRENGTH OF 450 MPa. THE CONTRACTOR SHALL CARRY OUT PROCEDURE TRIALS OF STUD WELDING.

6-WELDS SHALL BE MADE USING E70XX LOW HYDROGEN ELECTRODES U.N.O. SITE WELDING SHALL ONLY BE CARRIED OUT WITH THE PRIOR WRITTEN CONSENT OF THE ENGINEER AND AFTER SUBMISSION AND ACCEPTANCE OF FABRICATORS WELDING PROCEDURE. WELD TESTS INSPECTIONS PER AISC AND AWS D1.1.

7-WELDING PROCEDURE AND WORKMANSHIP SHALL BE IN ACCORDANCE WITH THE REQUIREMENTS OF AWS D1.1-2010 STRUCTURAL STEEL WELDING CODE.

8-NO CUTTING OR REMOVAL OF PLACED STEEL WORK OR CONCRETE IS PERMITTED WITHOUT PRIOR ACCEPTANCE BY THE ENGINEER.

9-FIRE PROTECTION TO STEELWORK IS GENERALLY PROVIDED BY CONCRETE ENCASEMENT TO BE IN ACCORDANCE WITH THE ARCHITECT'S SPECIFICATION.

10-THE CONTRACTOR SHALL CLEARLY IDENTIFY THE LOCATION OF SITE CONNECTIONS ON THE FABRICATION DRAWINGS TOGETHER WITH DETAILS OF AND CALCULATIONS FOR THOSE CONNECTIONS.

11-FOR FIRE RESISTANCE PERIODS, SHALL BE DESIGNED FOR MINIMUM 2.0 HRS FIRE RESISTANCE.

12-THE CONTRACTOR SHALL ENSURE THAT THE SYSTEMS SELECTED FOR CORROSION PROTECTION AND FIRE PROTECTION ARE COMPATIBLE AND SHALL OBTAIN ACCEPTANCE BY THE ENGINEER PRIOR APPLICATION.

13-WHERE COLD FORMED STEEL SECTIONS ARE SHOWN ON THE DRAWINGS, THE STEEL CONTRACTOR IS TO PROVIDE ALL NECESSARY STRUTS, ANTI SAG RODS, DIAGONAL TIES ETC, AS RECOMMENDED BY THE MANUFACTURER.

F-SPECIALTY ITEMS AND PRE-ENGINEERED ELEMENTS:

- 1-SPECIALTY ITEMS, PRE-ENGINEERED COMPONENTS, AND DESIGN/BUILD ELEMENTS ARE THOSE ITEMS WHICH ARE SPECIFIED IN THE CONSTRUCTION DOCUMENTS BUT REQUIRE THE DESIGN INPUT OF MANUFACTURER, SUPPLIER, AND OR INSTALLER TO BE SUBMITTED BY CONTRACTOR TO THE ENGINEER FOR COMMENTS AND / OR APPROVAL.
2-SPECIALTY ITEMS AND PRE-ENGINEERED COMPONENTS INCLUDE BUT ARE NOT LIMITED TO THE FOLLOWING:
a- STEEL TRUSSES.
b- STAIRS, HANDRAILS, GUARDRAILS & LANDSCAPING DETAILS.
c- EXTERIOR CURTAIN WALLS, CLADDING, AND GLAZING.
d- INTERIOR FACADE FRAMING.
e- SKYLIGHTS.
f- SUPPORT AND ANCHORAGE OF MECHANICAL, ELECTRICAL, AND PLUMBING EQUIPMENT AND COMPONENTS.
g- WINDOW WASHING EQUIPMENT SUPPORTS/BMU SUPPORT.
h- STEEL CRANE.
i- COLD FORMED STEEL STUDS.

3-THE ABOVE SHALL BE DESIGNED TAKING INTO CONSIDERATION THE CONCRETE AND MASONRY NOTES FOR MIX DESIGN, APPLICATION CODES, AND ANY DESIGN LOADS PROVIDED BY THE ENGINEER. IT SHOULD ALSO CONSIDER MANUFACTURER/SUPPLIER'S INSTALLATION MANUAL / RECOMMENDATION.

G-CONSTRUCTION:

1-MASS CONCRETE :
THE CONTRACTOR SHALL IMPLEMENT ALL NECESSARY MEASURES TO MONITOR AND AVOID CRACKING IN FRESH HYDRATING CONCRETE ANY ADDITIONAL REINFORCEMENT IF NEEDED WILL BE AT THE CONTRACTOR'S OWN EXPENSE MAXIMUM ADIABATIC TEMPERATURE RISE SHALL BE EQUAL TO 25 CELSIUS CONTRACTOR TO PROVIDE A LIST OF THESE MEASURES FOR ENGINEER APPROVAL.

2-M.E.P. AND ARCH. COMPONENTS SUPPORT:
SEISMIC LATERAL BRACING, SUPPORT AND ANCHORAGE OF ARCH. COMPONENT AND MECHANICAL, ELECTRICAL AND PLUMBING EQUIPMENT AND COMPONENTS SHALL BE DESIGNED AS PER CHAPTER 13 OF ACSE-T-2010 BY SUB-CONTRACTOR ENGINEER AND REVIEW FOR APPROVAL BY DESIGN ENGINEER.

3-CONSTRUCTION JOINTS:
CONTRACTOR TO SUBMIT POURS CONSTRUCTION JOINTS LOCATIONS AND CONSTRUCTION POURS SEQUENCE FOR STRUCTURAL ENGINEER APPROVAL. CONSTRUCTION JOINTS NOT SHOWN ON DRAWINGS SHALL BE APPROVED BY THE ENGINEER.
CONSTRUCTION JOINTS AT ANY SURFACE IN CONTACT WITH SOIL AND/OR WATER SHALL HAVE WATER STOP BAR (REFER TO SPECIFICATIONS).

4-AT ANY CONSTRUCTION JOINT THE CONTACT SURFACE BETWEEN THE OLD AND NEW CONCRETE SHALL BE ROUGHENED TO A FULL AMPLITUDE OF APPROXIMATELY 6mm. IF ADDITIONAL REINFORCEMENT AT CONTACT SURFACE IS REQUIRED BY THE ENGINEER, IT SHALL BE PROVIDED AT THE EXPENSE OF THE CONTRACTOR.

4-FOR FLOOR FLATNESS AND LEVELNESS, REFER TO ARCHITECTURAL SPECIFICATIONS AND ACI 302.1R: "GUIDE FOR CONCRETE FLOOR AND SLAB CONSTRUCTION".

5-CONTRACTOR IS RESPONSIBLE FOR TEMPORARY, PERMANENT, EXCAVATION, BACKFILL, SHORING, DEWATERING, PROTECTION AND SIMILAR WHEN NEEDED.

H-FIRE DESIGN :

1-FIRE DESIGN SHALL BE IN ACCORDANCE WITH BUILDING CONSTRUCTION AND SAFETY CODE(NFPA 5000).

2-MINIMUM CONSTRUCTION REQUIREMENTS:
ALL STRUCTURE MEMBERS SHALL BE DESIGNED FOR MINIMUM 2.0 HOURS BUILDING TYPE I(32).

3-REFER TO FIRE SAFETY REPORT PROVIDED BY -DESIGN FIRE CONSULTANTS.


LAP SPLICE LENGTHS OF DEFORMED BARS IN TENSION

fc = 28 MPa	LAP SPLICE	UNCOATED BARS			
		TOP BARS		OTHER BARS	
Bar sizes	CASE 1	CASE 2	CASE 1	CASE 2	
Ø10 to Ø20	Class A	50 BAR DIA	74 BAR DIA	38 BAR DIA	57 BAR DIA
	Class B	64 BAR DIA	96 BAR DIA	50 BAR DIA	74 BAR DIA
Ø22 to Ø57	Class A	62 BAR DIA	93 BAR DIA	47 BAR DIA	71 BAR DIA
	Class B	80 BAR DIA	121 BAR DIA	62 BAR DIA	93 BAR DIA

NOTES:

- 1- TABULATED TENSION DEVELOPMENT LENGTH VALUES ARE TAKEN FROM CRSI DESIGN HANDBOOK 2008 10TH ED.
- 2- TENSION DEVELOPMENT & TENSION LAP SPLICE LENGTHS ARE EXPRESSED AS MULTIPLES OF BAR DIAMETERS.
- 3- TABULATED VALUES ARE BASED ON MINIMUM YIELD STRENGTH OF REINFORCEMENT, FY, OF 420MPA.
- 4- CONCRETE IS NORMAL WEIGHT (2400KG/M³) AND 28 DAY COMPRESSIVE STRENGTH = 28MPA.
- 5- TABULATED VALUES FOR BEAMS & COLUMNS ARE BASED ON TRANSVERSE REINFORCEMENT AND CONCRETE COVER MEETING MINIMUM CODE REQUIREMENTS.
- 6- CASES 1 & 2, WHICH DEPEND ON THE TYPE OF STRUCTURAL MEMBER, CONCRETE COVER, AND CENTER-TO-CENTER SPACING OF THE BARS ARE DEFINED IN THE TABLE BELOW.
- 7- LAP SPLICE LENGTHS (MINIMUM 300MM) ARE MULTIPLES OF TENSION DEVELOPMENT LENGTHS: CLASS A = 1.0(TENSION DEVELOPMENT LENGTH) & CLASS B = 1.3(TENSION DEVELOPMENT LENGTH)
- 8- TOP BARS ARE HORIZONTAL REINFORCEMENT WITH MORE THAN 300MM OF CONCRETE CAST BELOW THE BARS.
- 9- IT SHALL BE PERMISSIBLE TO CALCULATE WALL AND SLAB REINFORCEMENT TENSION DEVELOPMENTS/SPICE LENGTHS IN ACCORDANCE WITH ACI 12.2.3 OR TABLE 5.3(B) OF ACI 2014 IN LIEU OF VALUES TABULATED ABOVE.

BEAMS, COLUMNS	CASE 1	CONCRETE COVER AT LEAST 1 BAR DIA AND CENTER-TO-CENTER SPACING AT LEAST 2 BAR DIA
	CASE 2	CONCRETE COVER LESS THAN 1 BAR DIA OR CENTER-TO-CENTER SPACING LESS THAN 2 BAR DIA
ALL OTHERS	CASE 1	CONCRETE COVER AT LEAST 1 BAR DIA AND CENTER-TO-CENTER SPACING AT LEAST 3 BAR DIA
	CASE 2	CONCRETE COVER LESS THAN 1 BAR DIA OR CENTER-TO-CENTER SPACING LESS THAN 3 BAR DIA

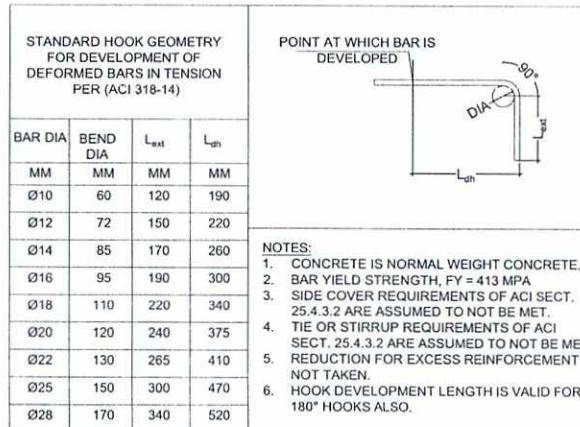

EXTRA BARS EQUAL IN TOTAL AREA TO REGULAR REINFORCING CUT BY OPENING. PLACE ONE HALF TOTAL AREA TO EACH SIDE OF OPENING AND IN THE SAME TRANSVERSE POSITION AS REGULAR REINFORCING.

ONE EXTRA BAR EACH CORNER PER LAYER OF REGULAR REINFORCING (SEE TABLE BELOW). PLACE IN SAME TRANSVERSE POSITION AS REGULAR REINFORCING.


REINFORCING SCHEDULE		
THICKNESS OF CONCRETE	BAR SIZE	BAR LENGTH
< 300	D12	1200 D+300
300 TO 450	D16	1200 D+300
450 TO 600	D22	1500 D+300
> 600	D25	1800 D+450

EXTRA BARS EQUAL IN TOTAL AREA TO REGULAR REINFORCING CUT BY OPENING. PLACE ONE HALF TOTAL AREA TO EACH SIDE OF OPENING AND IN THE SAME TRANSVERSE POSITION AS REGULAR REINFORCING.


ONE EXTRA BAR EACH CORNER PER LAYER OF REGULAR REINFORCING (SEE TABLE BELOW). PLACE IN SAME TRANSVERSE POSITION AS REGULAR REINFORCING.

REINFORCING SCHEDULE		
THICKNESS OF CONCRETE	BAR SIZE	BAR LENGTH
< 300	D12	1200 D+300
300 TO 450	D16	1200 D+300
450 TO 600	D22	1500 D+300
> 600	D25	1800 D+450

FOR OPENING LARGER THAN 500 IN DIAMETER OR DIAGONAL TYPICAL EXTRA REINFORCING AT OPENINGS IN WALLS AND SLABS

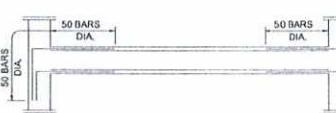

NOTE:
- FOR ALL BILLS AND LINTELS BETWEEN COLUMNS AND NOT SUPPORTED BY A WALL, PROVIDE DOWELS IN THE COLUMN OF SAME SIZE AND NUMBER AS THE REINFORCEMENT OF THE LINTEL/BILL. THESE DOWELS SHALL EXTEND 50 BAR DIA. FROM THE FACE OF THE COLUMN AND SHALL BE EMBEDDED 50 BAR DIA. IN THE COLUMN.

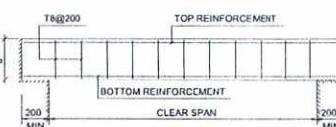9 TYP. LINTEL DETAIL

SCHEDULE OF LINTELS REINFORCEMENT								
LINTEL SPAN #	b=100cm,	b=150cm,	b=200cm OR 250cm	b=400cm,	DEPTH #			
< 200	1T10	1T14	2T10	2T12	4T10	4T12	20	
200-300	1T10	1T16	2T10	2T14	2T10	4T16	25	
301-400	1T10	1T20	2T10	2T16	2T10	4T18	30	
401-500	1T10	1T20	2T10	2T16	2T10	4T20	40	
501-600	1T10	1T20	2T10	2T16	2T10	4T20	50	
601-700	1T12	1T25	2T12	4T20 in 2 layers	2T12	2T25	4T25	60


OR: PROVIDE CATNIC TYPE STEEL LINTELS OF DEPTH AND THICKNESS APPROPRIATE TO SPAN AND LOAD CARRIED.

SERVICES DIRECTORATE COMPLEX BUILDING
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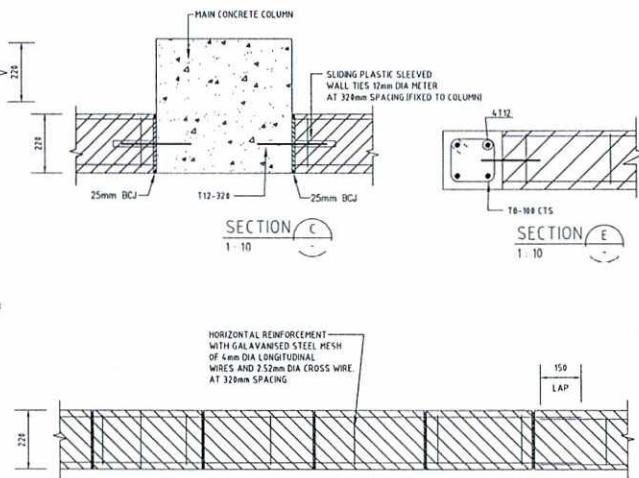
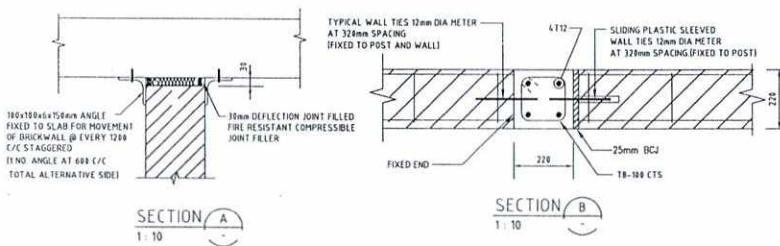
POWER PLANT BUILDING

GENERAL NOTE

Sheet Reference Number
S-002

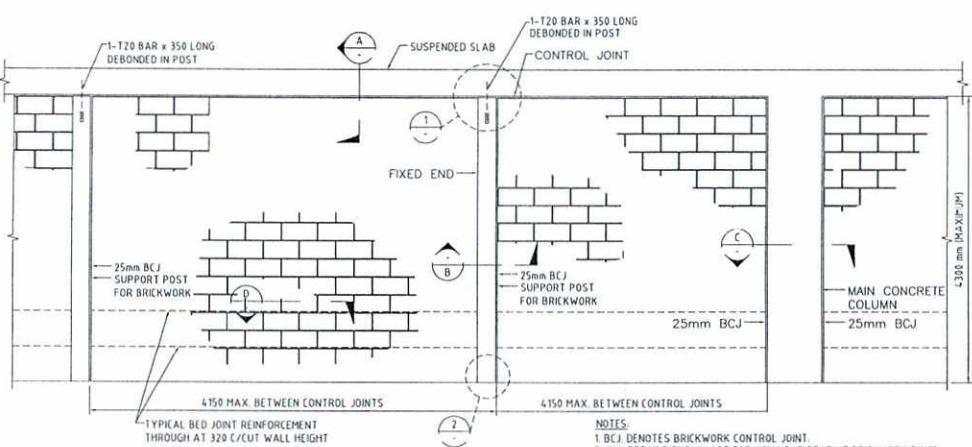


TYPICAL ELEVATION FOR 220mm THICK BRICKWORK




SECTION D

NOTES


- ALL CONTROL JOINTS ARE TO BE FILLED WITH COMPRESSIBLE EXPANDABLE FILLER.
 - GREAT CARE MUST BE TAKEN TO ENSURE THAT MORTAR DROPPINGS AND OTHER HARD MATERIALS DO NOT FALL OR REMAIN IN THE CONTROL JOINTS. POLYSTYRENE IS TO BE PLACED IN ALL VERTICAL JOINTS DURING CONSTRUCTION IN MASONRY TO AVOID MORTAR DROPPINGS FILLING THE JOINTS.
 - ALL JOINTS ARE TO BE REVIEWED AND APPROVED BY THE ENGINEER OR HIS REPRESENTATIVE PRIOR TO USE.
 - WHERE FILLER MATERIALS ARE NOT SPECIFIED BY A TRADE NAME, THE CONTRACTOR SHALL SUBMIT THE NAME OF HIS PROPOSED FILLERS TO THE DESIGN TEAM FOR REVIEW PRIOR TO USE.
 - THE CONTRACTOR'S ATTENTION IS DRAWN TO THE MANUFACTURER'S REQUIREMENTS WITH REGARD TO THE POSITION OF THE FLEXIBLE ANCHORS WHEN FIXED. THE MANUFACTURER'S WRITTEN RECOMMENDATIONS SHALL BE FOLLOWED STRICTLY.
 - THE CONTRACTOR IS TO TAKE PARTICULAR CARE TO ENSURE THAT ALL PERPENDS AND BEDS ARE PROPERLY FILLED WITH MORTAR.
 - PROVIDE RESTRAINT TO ALL MASONRY AT SOFFIT OF SLAB OVER AS REQUIRED.
 - PROVIDE HORIZONTAL BED JOINT REINFORCEMENT AS PER SPECIFICATIONS AND DETAILS ON DRAWINGS.
 - PROVIDE LINTELS OVER ALL OPENINGS OR RECESSES IN MASONRY WALLS, INCLUDING THOSE OPENINGS FOR MECHANICAL OR ELECTRICAL SERVICES OR EQUIPMENT.
 - 12mm DIA TIES @ MAXIMUM 320C/C TO ALL STRUCTURE COLUMN/SHEAR WALLS VERTICALLY WITH MINIMUM 125MM FULL EMBEDMENT EACH SIDE OF THE ANCHOR.
 - WATER ABSORPTION OF BRICKS SHOULD NOT BE MORE THAN 15%
 - COMPRESSIVE STRENGTH OF INDIVIDUAL BRICK = 2000PSI MINIMUM.
 - CONCRETE STRENGTH FOR POSTS = 4000PSI
 - COMPRESSIVE STRENGTH OF MASONRY FROM PRISM TEST fm' = 750PSI
 - YIELD STRENGTH OF REINFORCEMENT = 60000PSI
 - MORTAN JOINTS THICKNESS = 10mm.

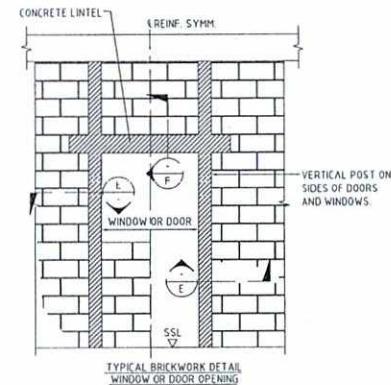


TYPICAL BRICKWORK DETAIL
WINDOW OR DOOR OPENING

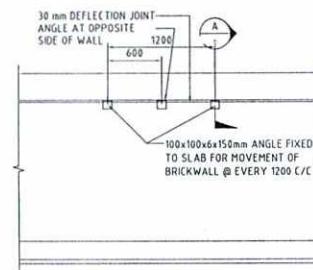

EL E V A T I O N AT T O P O F N O N - L O A D B E A R I N G
B R I C K W O R K W A L L

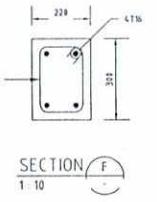

SECTION F

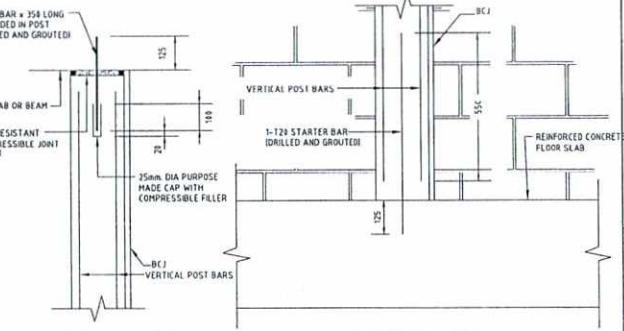

DETAIL 1



امارت اسلامی الفغانستان
ریاست عمومی اداره امور
معاونیت مالی و اداری
مت طرح و نیز این امور ساخته
امربت مهندسی

Tel: 0202143082 Website: www.aop.gov.au

Designed by	Mutasim Bilal Jarar		No.	Submission Description:	Date:
Drawn by:	Mutasim Bilal Jarar		(1)	For Construction	1403/0
Checked By Head of Department :	Noorulhuda Haqani		(2)		
Approved by Visa Committee:	M.Musa Essazai		(3)		
			(4)		
			(5)		

Contract No:	
Contract Date:	
Fiscal Year:	1403/1445
Drawn Code:	SDCB
Paper Size:	A3
Plot Date:	1403/04/09
Scale:	1:00


SERVICES DIRECTORATE COMPLEX BUILDING
AOP
KABUL PROVINCE , AFGHANISTAN

POWER PLANT BUILDING






330MM BRICK WORK DETAILS

Sheet
Reference
Number

S-003

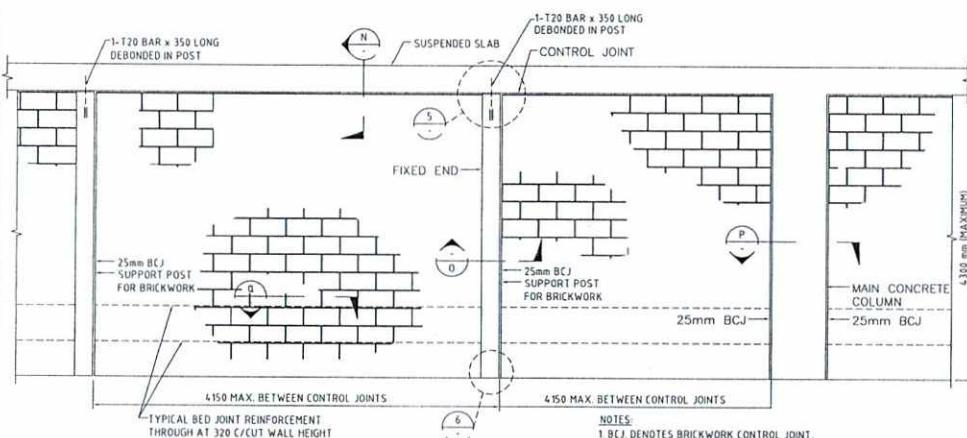**NOTES**

- 1 ALL CONTROL JOINTS ARE TO BE FILLED WITH COMPRESSIBLE EXPANDABLE FILLER.
- 2 GREAT CARE MUST BE TAKEN TO ENSURE THAT MORTAR DROPPINGS AND OTHER HARD MATERIALS DO NOT FALL OR REMAIN IN THE CONTROL JOINTS. POLYSTYRENE TO BE PLACED IN ALL VERTICAL JOINTS DURING CONSTRUCTION IN MASONRY TO AVOID MORTAR DROPPINGS FILLING THE JOINTS.
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امارت اسلامی افغانستان
ریاست عمومی اداره امور
معاونت مالی و اداری
ریاست طرح توسیع امور ساختمانی
آموزت مهندسی

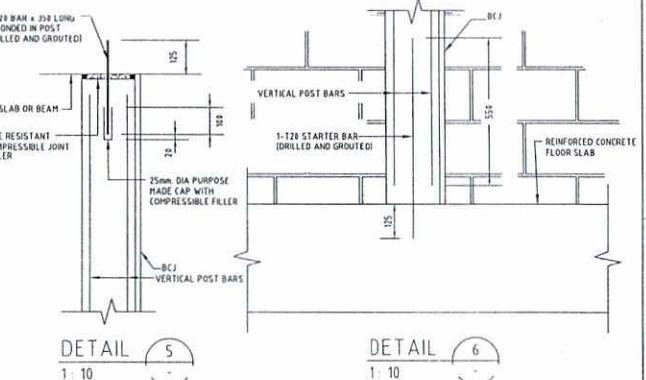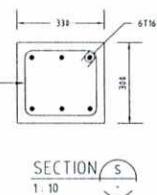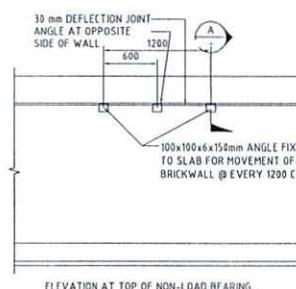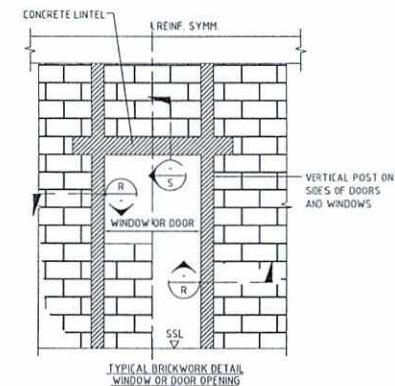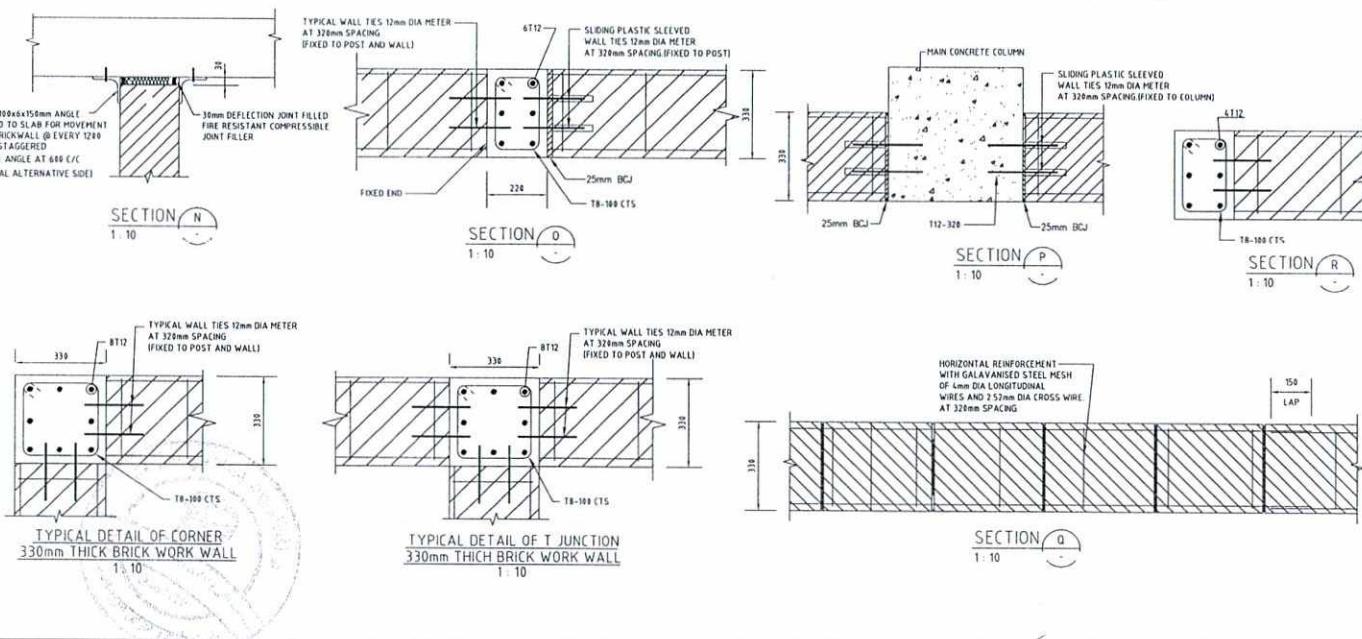
Tel: 0202143082 Website: www.aop.gov.af

Designed by:	Mutasim Bilal Jarar	No:	Submission Description:	Date:
Drawn by:	Mutasim Bilal Jarar	(01)	For Construction	1403/04/15
Checked By Head of Department:	Noorulhuda Haqani	(02)		
Approved by Visa Committee:	M. Musa Essazai	(03)		
		(04)		
		(05)		

Contract No:	
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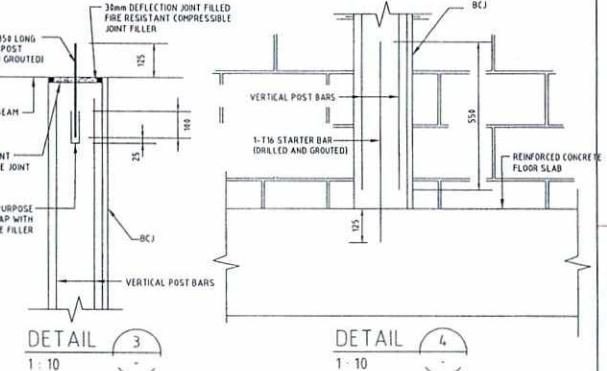
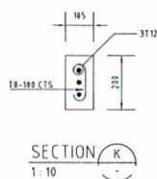
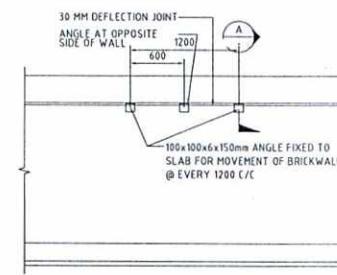
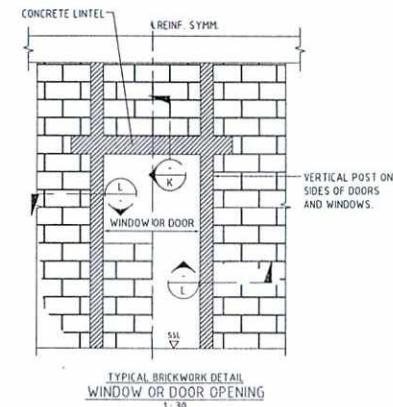
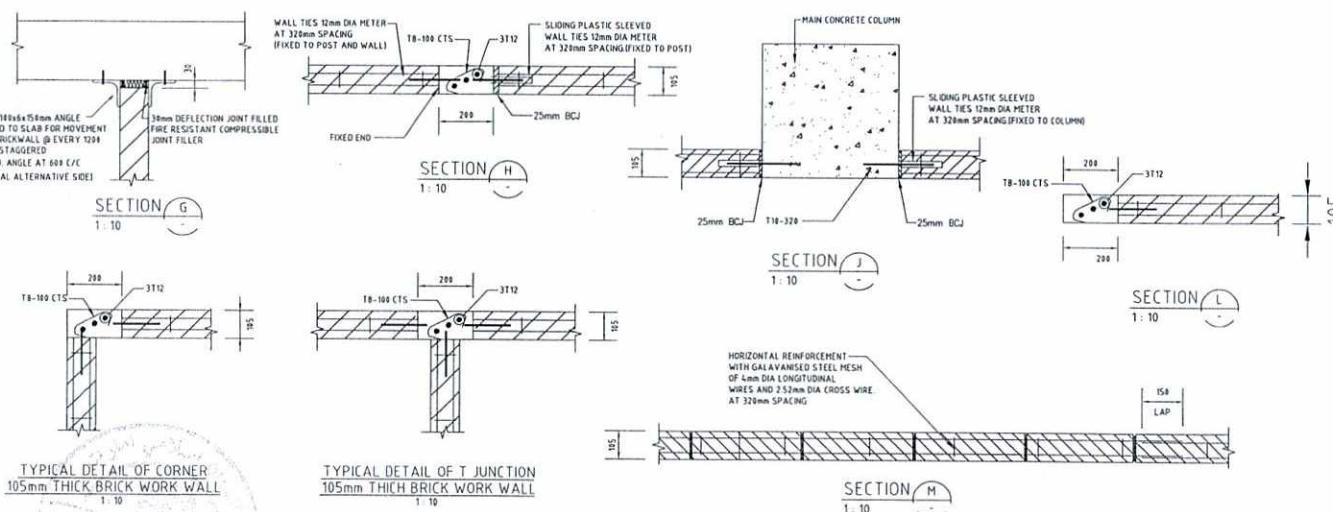
SERVICES DIRECTORATE COMPLEX BUILDING
AOP
KABUL PROVINCE, AFGHANISTAN
POWER PLANT BUILDING
330MM BRICK WORK DETAILS

Sheet Reference Number
S-005

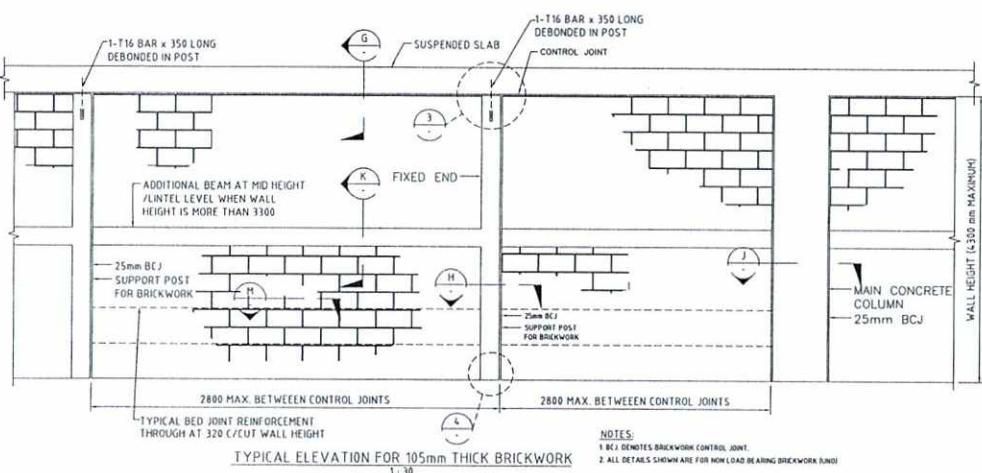

NOTES

- ALL CONTROL JOINTS ARE TO BE FILLED WITH COMPRESSIBLE EXPANDABLE FILLER.
- GREAT CARE MUST BE TAKEN TO ENSURE THAT MORTAR DROPPINGS AND OTHER HARD MATERIALS DO NOT FALL OR REMAIN IN THE CONTROL JOINTS. POLYSTYRENE TO BE PLACED IN ALL VERTICAL JOINTS DURING CONSTRUCTION IN MASONRY TO AVOID MORTAR DROPPINGS FILLING THE JOINTS.
- ALL JOINTS ARE TO BE REVIEWED AND APPROVED BY THE ENGINEER OR HIS REPRESENTATIVE PRIOR TO USE.
- WHERE FILLER MATERIALS ARE NOT SPECIFIED BY A TRADE NAME, THE CONTRACTOR SHALL SUBMIT THE NAME OF HIS PROPOSED FILLERS TO THE DESIGN TEAM FOR REVIEW PRIOR TO USE.
- THE CONTRACTOR'S ATTENTION IS DRAWN TO THE MANUFACTURER'S REQUIREMENTS WITH REGARD TO THE POSITION OF THE FLEXIBLE ANCHORS WHEN FIXED. THE MANUFACTURER'S WRITTEN RECOMMENDATIONS SHALL BE FOLLOWED STRICTLY.
- THE CONTRACTOR IS TO TAKE PARTICULAR CARE TO ENSURE THAT ALL PERPENDS AND BEDS ARE PROPERLY FILLED WITH MORTAR.
- PROVIDE RESTRAINT TO ALL MASONRY AT SOFFIT OF SLAB OVER AS REQUIRED.
- PROVIDE HORIZONTAL BED JOINT REINFORCEMENT AS PER SPECIFICATIONS AND DETAILS ON DRAWINGS.
- PROVIDE LINTELS OVER ALL OPENINGS OR RECESSES IN MASONRY WALLS, INCLUDING THOSE OPENINGS FOR MECHANICAL OR ELECTRICAL SERVICES OR EQUIPMENT.
- 12mm DIA TIES @ MAXIMUM 320/C/M TO ALL STRUCTURE COLUMN/SHEAR WALLS VERTICALLY WITH MINIMUM 125MM FULL EMBEDMENT EACH SIDE OF THE ANCHOR.
- WATER ABSORPTION OF BRICKS SHOULD NOT BE MORE THAN 15%.
- COMPRESSIVE STRENGTH OF INDIVIDUAL BRICK >2000PSI MINIMUM.
- CONCRETE STRENGTH FOR POSTS >4000PSI
- COMPRESSIVE STRENGTH OF MASONRY FROM PRISM TEST fm' = 750PSI
- YIELD STRENGTH OF REINFORCEMENT = 60000PSI
- MORTAR JOINTS THICKNESS = 10mm.



امارت اسلامی الفاضل

ریاست عمومی اداره امور

ملوکتیت مالی و تاری

ریاست طرح و دیزاین امور ساخته

امرت مهندس


Tel: 0202143082 Website: www.aop.gov.af

Designed by:	Mutasim Bilal Jarar	No.	Submission Description:	Date:
Drawn by:	Mutasim Bilal Jarar	(G1)	For Construction	1403/04/15
Checked By Head of Department:	Noorulhuha Haqani	(G2)		
Approved by Visa Committee:	M.Musa Essaai	(G3)		
		(G4)		
		(G5)		

Contract No:	
Contract Date:	
Fiscal Year:	1403/1445
Drawn Code:	SDCB
Paper Size:	A3
Plot Date:	1403/04/09
Scale:	1:100

SERVICES DIRECTORATE COMPLEX BUILDING
AOP
KABUL PROVINCE, AFGHANISTAN
POWER PLANT BUILDING
330MM BRICK WORK DETAILS

Sheet Reference Number
S-004

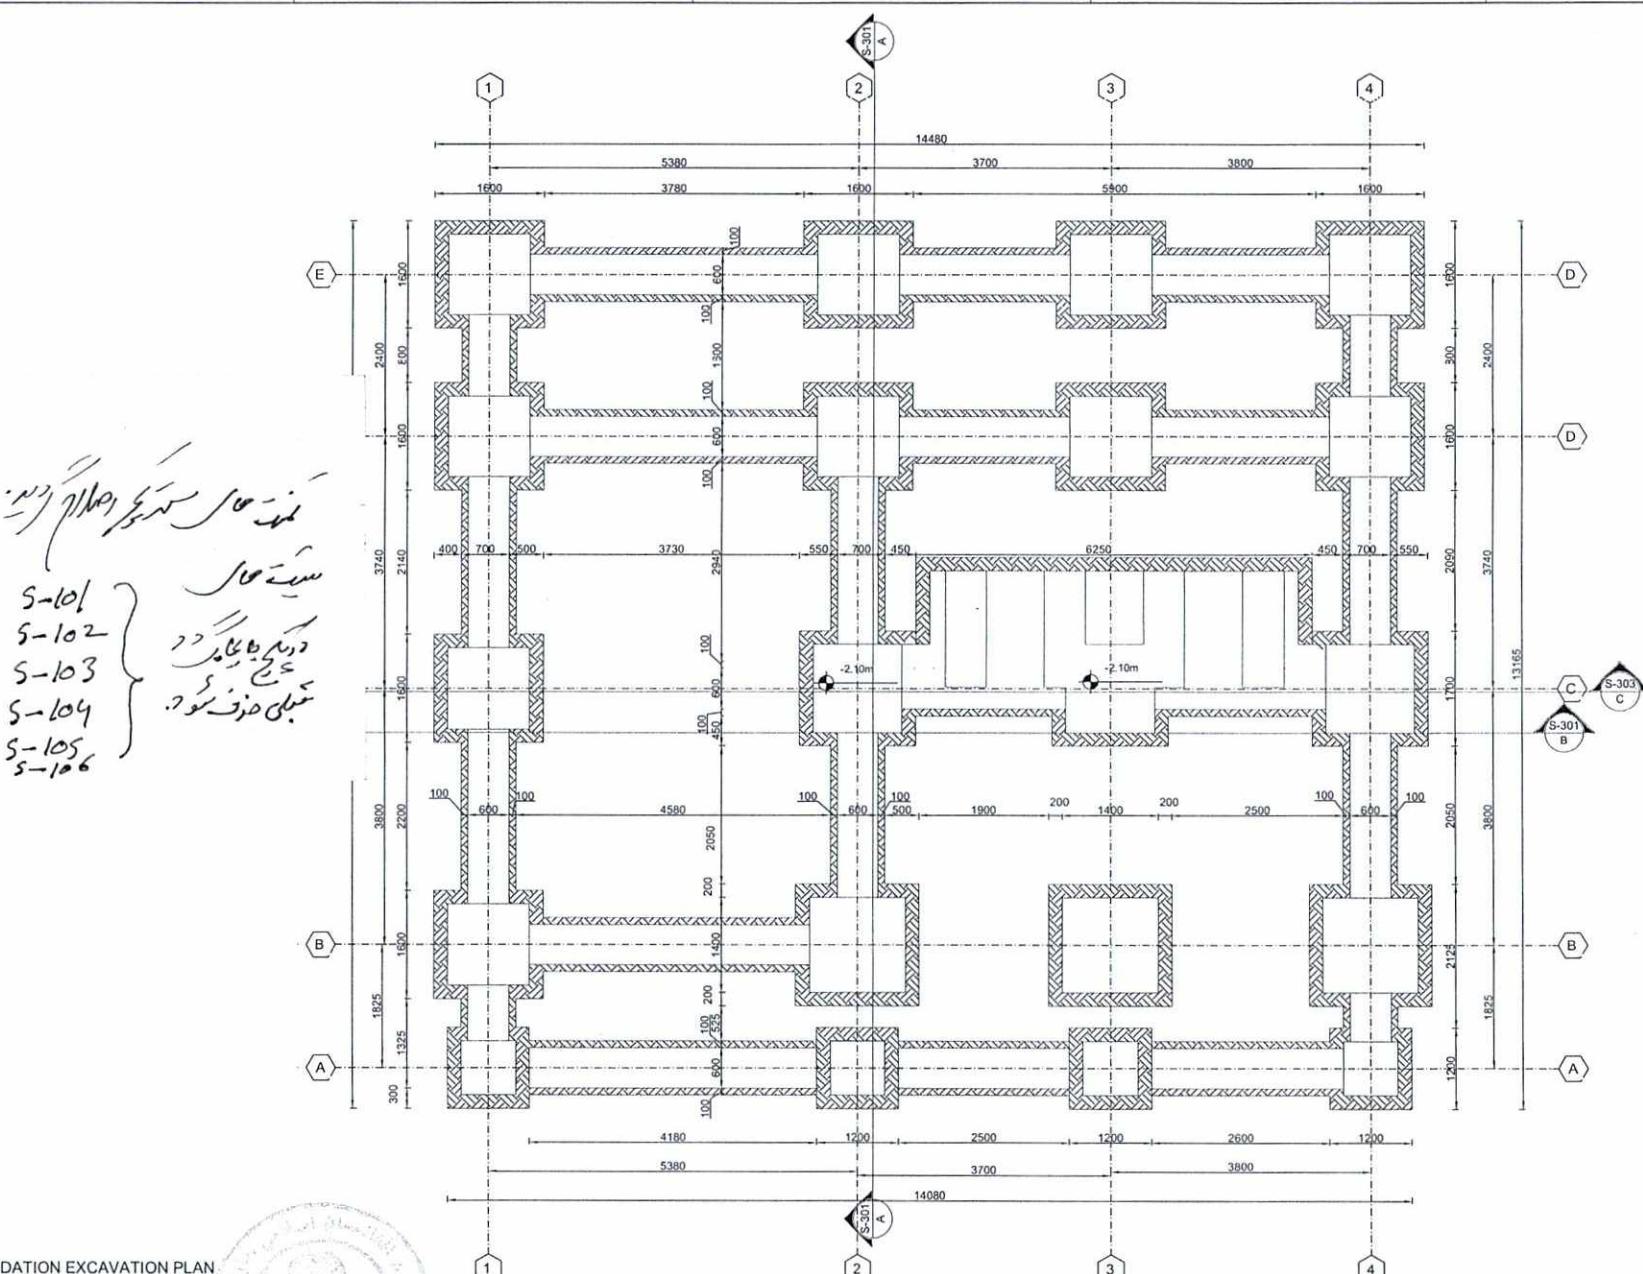

01 | FOUNDATION EXCAVATION PLAN

S-101 REF: _____ SCALE: 1:40



امارت اسلامی افغانستان
ریاست عمومی اداره امور
معارنیست مالی و اداری
پلست طرح و دیزاین امور ساختمانی

Tel: 0202143082 Website: www.sop.gov.af

Designed by:	Mutasim B
Drawn by:	Mutasim B
Checked By Head of Department :	Noorulhusn
Approved by Visa Committee:	M.Musa B

No.	Submission Description	Date:
01	For Construction	1403/01
02		
03		
04		
05		

SERVICES DIRECTORATE COMPLEX BUILDING
AOP
KABUL PROVINCE , AFGHANISTAN

POWER PLANT BUILDING


FOUNDATION EXCAVATION PLAN

POWER PLANT BUILDING
FOUNDATION EXCAVATION PLAN

Sheet
Reference
Number

S-101

1 2 3 4 5

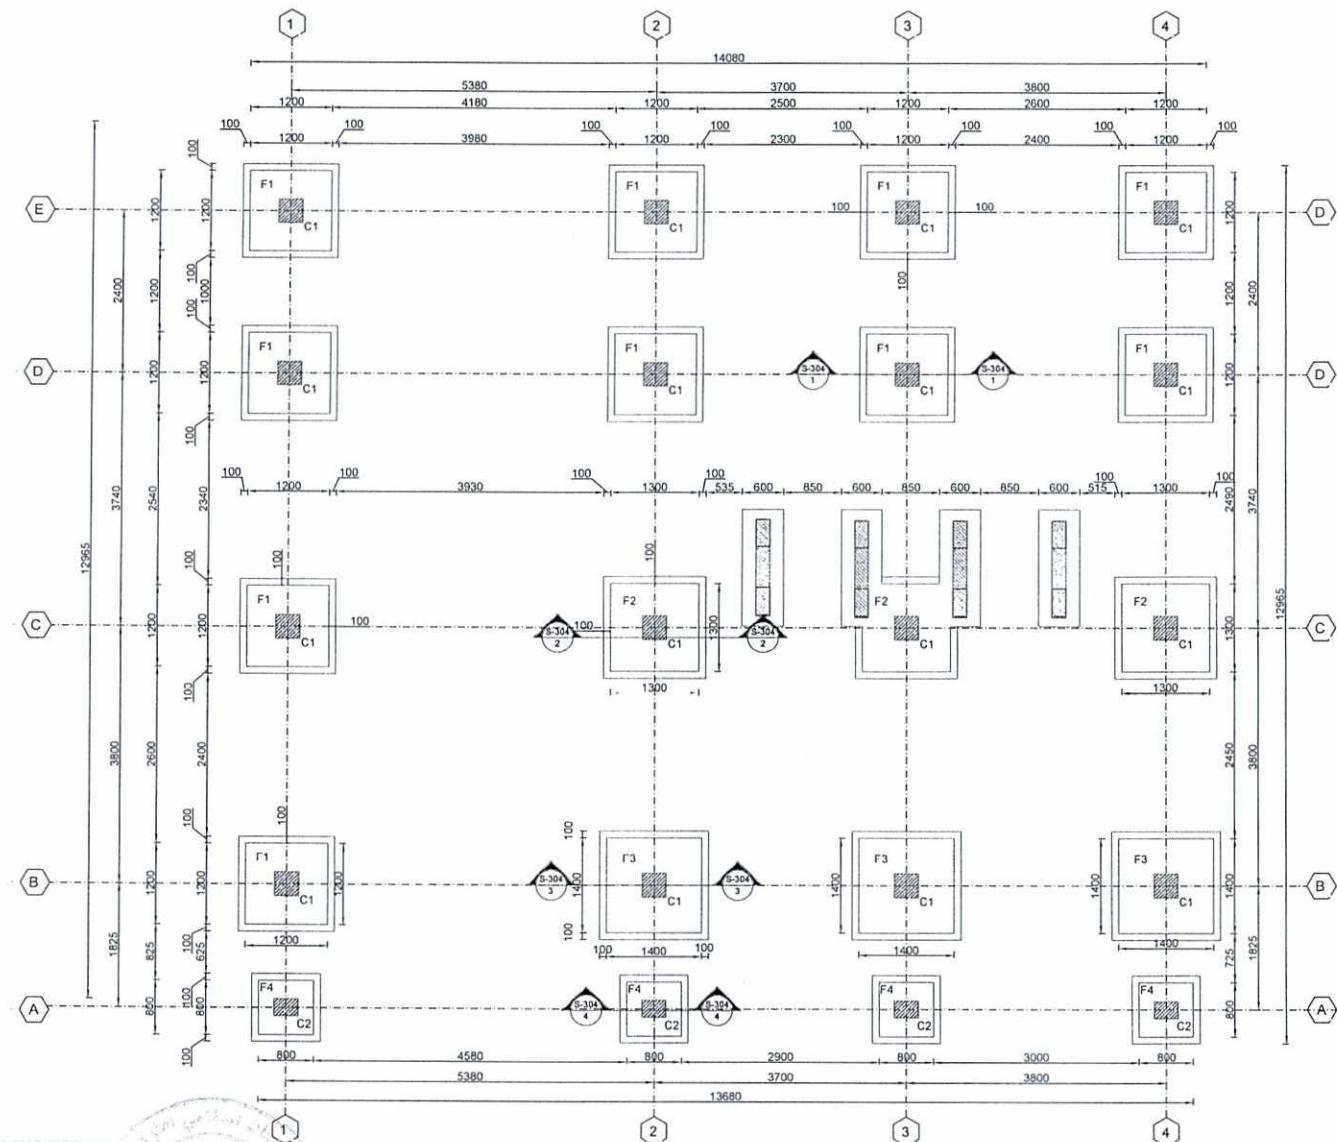

01 | FOUNDATION AND COLUMN LAYOUT PLAN
S-102 REF: SCALE-1:40



امارت اسلامی القائمه
وزارت عمومی اداره امور
محلویتی مالی و اداری
رواست طرح و نیز امن امور ساخته
وزیر مهندسی

Tel: 0202143082 Website: www.aop.gov.af

Designed by: Mutasim Billah Jarar
Drawn by: Mutasim Billah Jarar
Checked By Head of Department: Noonilhuda Haqani
Approved by Visa Committee: M.Musa Essazai


No.	Submission Description	Date:
(01)	For Construction	1403/04/15
(02)		
(03)		
(04)		
(05)		

Contract No:
Contract Date:
Fiscal Year: 1403/1445
Drawn Code: SDCB
Paper Size: A3
Plot Date: 1403/04/09
Scale: 1:00

SERVICES DIRECTORATE COMPLEX BUILDING
AOP
KABUL PROVINCE, AFGHANISTAN
POWER PLANT BUILDING
FOUNDATION AND COLUMN LAYOUT PLAN

Sheet Reference Number
S-102

NOTE:
 1. ALL DIMENSIONS ARE IN MILLIMETER
 2. GRADE OF REBAR = fy = 60 ksi = 4180 Kg/cm²
 3. GRADE OF REINFORCED CONC. = f'c = 4000 psi
 = 280 Kg/cm²

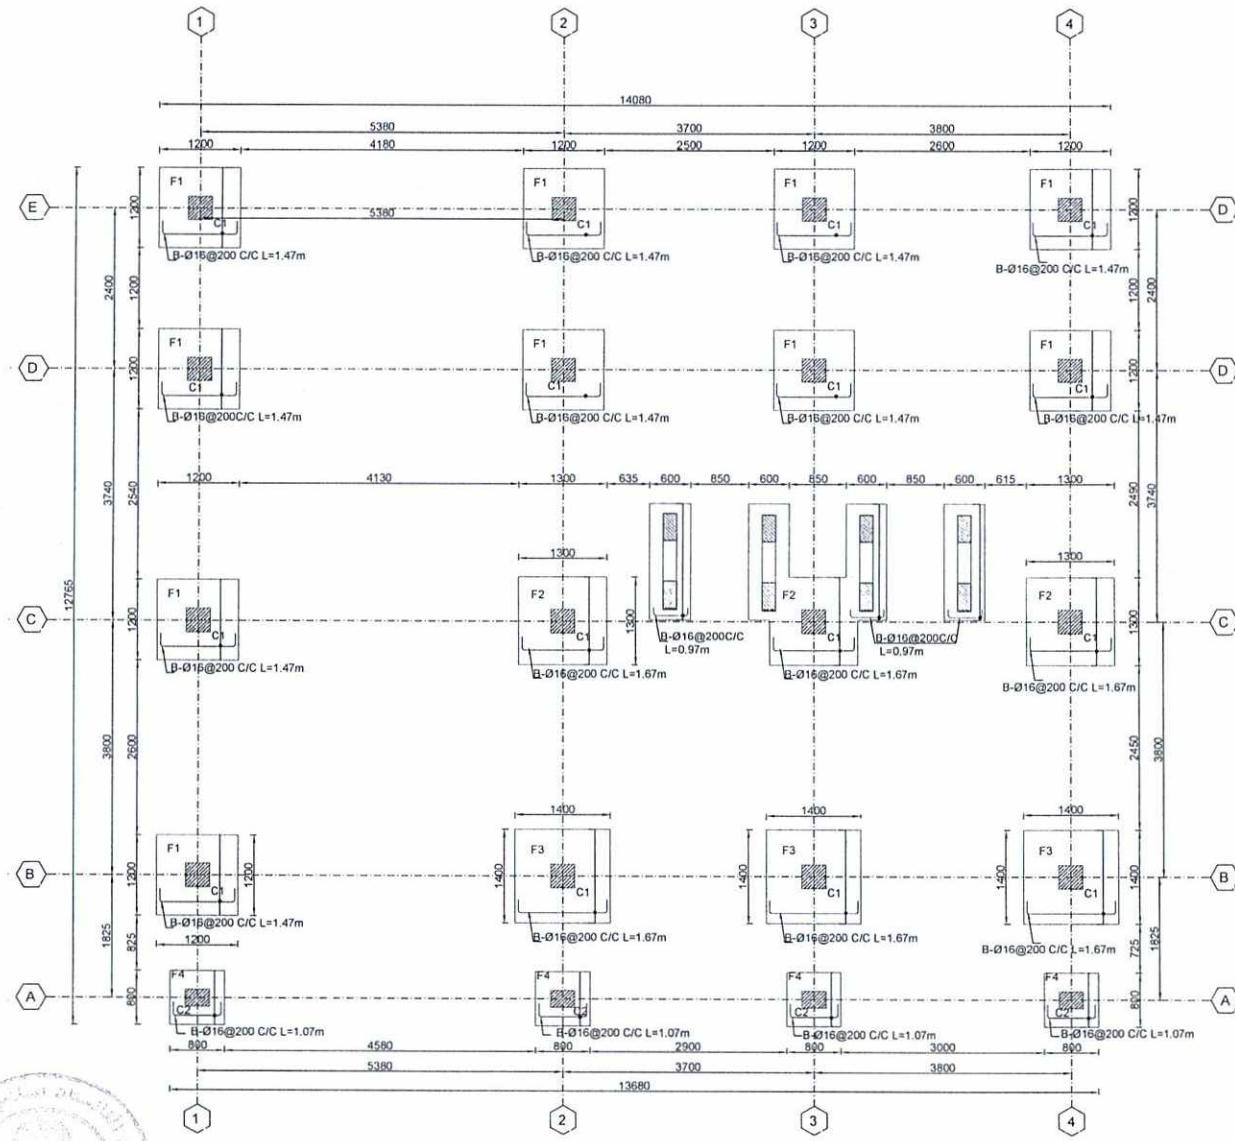

01 | BOT-(X-DIRECTION) REINFORCEMENT FOUNDATION PLAN

SCALE- 1:40

لیارت اسلامی افغانستان
ریاست حکومی اداره امور
معلویت ملی و اداری

پالست طرح و دیزاین امور مهندسی
امربیت مهندسی

Designed by:	Mutasim Billah Jarar		No.	Submission Description	Date:
Drawn by:	Mutasim Billah Jarar		<input checked="" type="checkbox"/> 01	For Construction	1403/04/15
Checked By Head of Department:	Noonkhuda Haqani		<input type="checkbox"/> 02		
Approved by Visa Committee	M.Musa Essazai		<input type="checkbox"/> 03		
			<input type="checkbox"/> 04		
			<input type="checkbox"/> 05		

Contract No.	
Contract Date.	
Fiscal Year.	1403/1445
Drawn Code.	SDCB
Paper Size:	A3
Plot Date:	1403/04/09
Scale:	1:00

SERVICES DIRECTORATE COMPLEX BUILDING
AOP
KABUL PROVINCE, AFGHANISTAN

POWER PLANT BUILDING


BOT-(X-DIRECTION) REINFORCEMENT FOUNDATION

Sheet
Reference
Number

S-103

NOTE

- ALL DIMENSIONS ARE IN MILLIMETER UNLESS OTHERWISE NOTED.
 - GRADE OF REBAR = $f_y = 60$ ksi = 4180 kg/cm 2
 - GRADE OF REINFORCED CONC. = $f'_c = 4000$ psi = 280 kg/cm 2

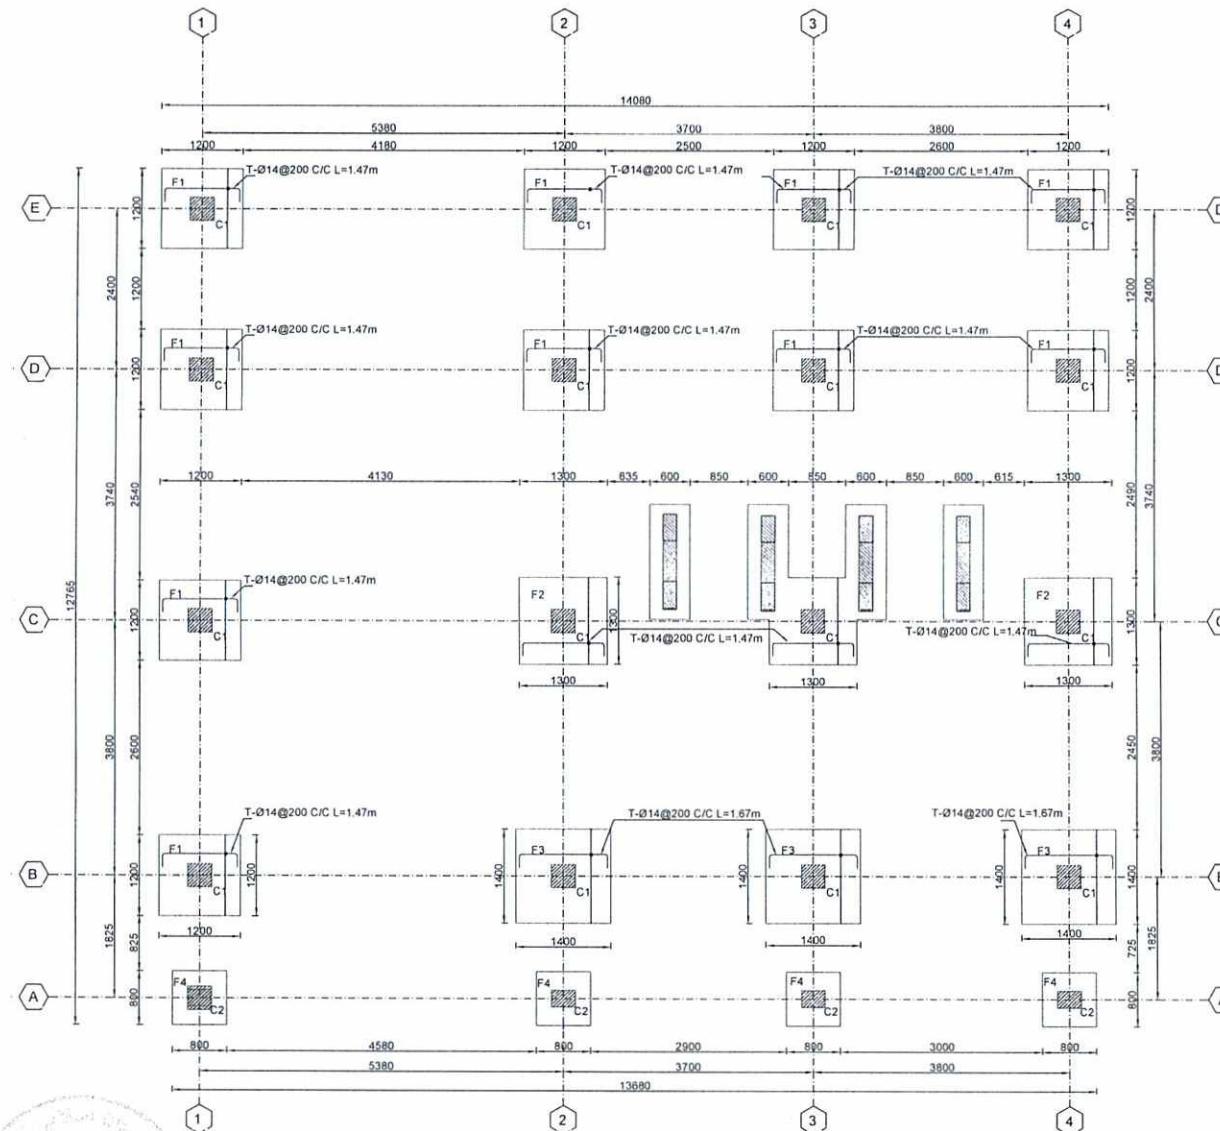

NOTE :



- 1. ALL DIMENSIONS ARE IN MILLIMETER UNLESS OTHERWISE NOTED.
- 2. GRADE OF REBAR $f_y = 60 \text{ Ksi} = 4180 \text{ Kg/cm}^2$
- 3. GRADE OF REINFORCED CONC. $f'_c = 4000 \text{ psi} = 280 \text{ Kg/cm}^2$

01 | TOP(X-DIRECTION) REINFORCEMENT FOUNDATION PLAN
S-104 REF: SCALE- 1:40



بلت اسلامی افغانستان
ریاست عمومی اداره امور
معاونیت مالی و اداری
طرح و دیزاین امور ساختمانی
امربیت مهندسی

- لیاقت اسلامی افغان
- ریاست حکومی افغان
- معاونیت مالی افغان
- ریاست طرح و دیزاین افغان
- امربیت مهندسی افغان

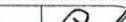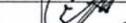
Designed by:	Mutasim Billah Jarar	
Drawn by:	Mutasim Billah Jarar	
Checked By Head of Department:	Noonulhuda Haqani	
Approved by Visa Committee:	M.Musa Essazai	

Submission Description:	Date	Contract No.:
For Construction	1403/04/15	Contract Date:
		Fiscal Year:
		Drawn Code:
		Paper Size:
		Plot Date:
		Scale:

SERVICES DIRECTORATE COMPLEX BUILDING
ACP
KABUL PROVINCE , AFGHANISTAN
POWER PLANT BUILDING
TOP(X-DIRECTION) REINFORCEMENT FOUNDATION PLAN

Sheet
Reference
Number

S-10-

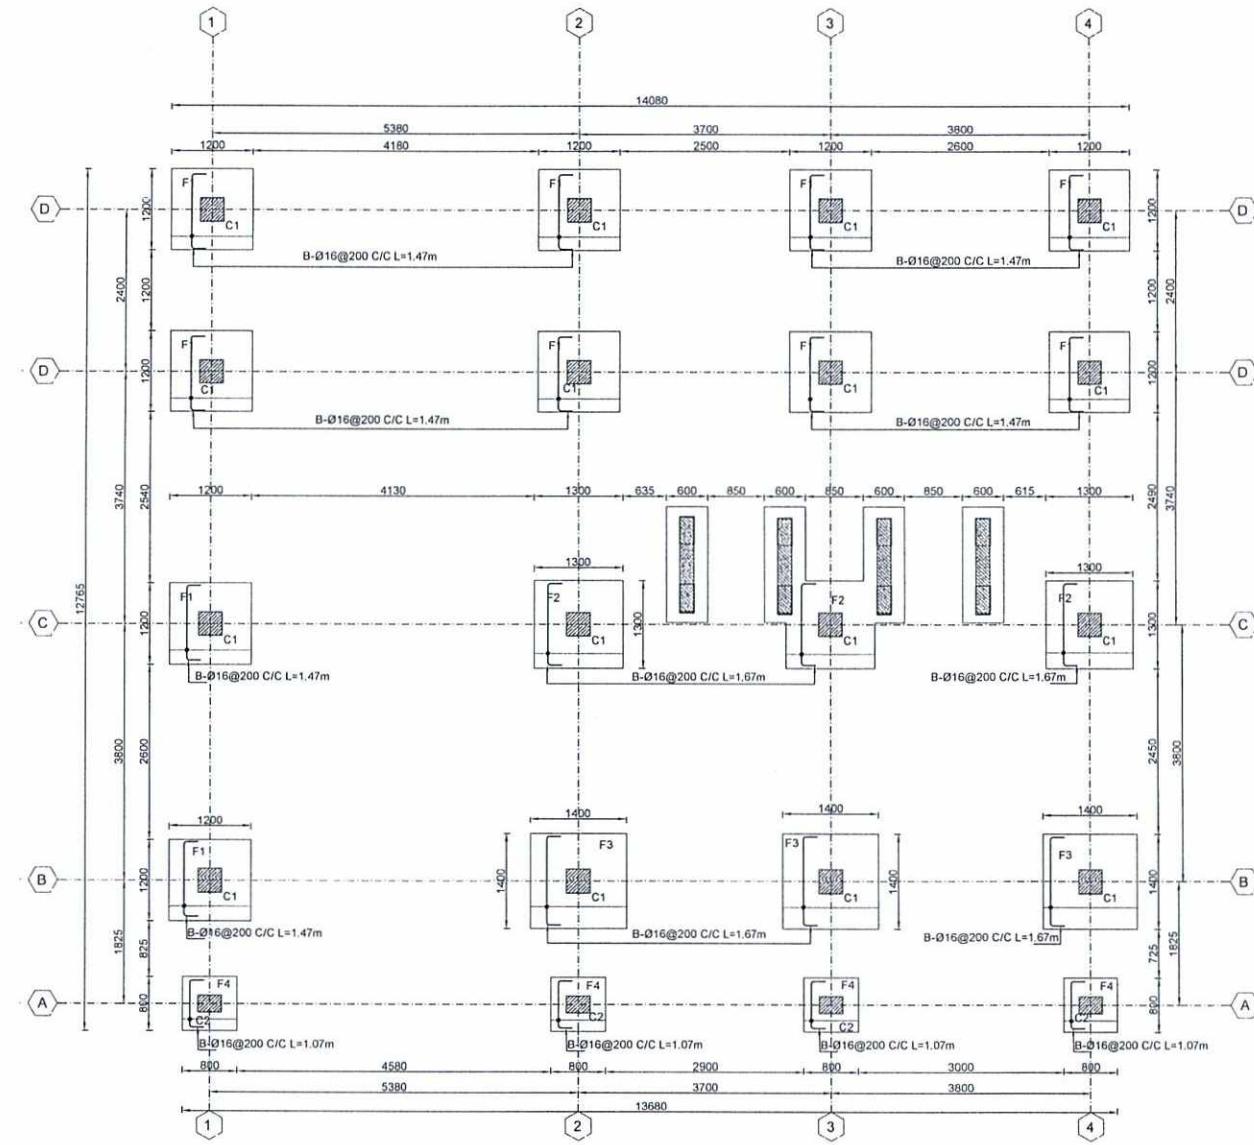

NOTE:
 1. ALL DIMENSIONS ARE IN MILLIMETER
 UNLESS OTHERWISE NOTED.
 2. GRADE OF REBAR = fy = 60 ksi = 4180 Kg/cm².
 3. GRADE OF REINFORCED CONC. = fc' = 4000 psi
 = 280 Kg/cm²

01 | BOT-(Y-DIRECTION) REINFORCEMENT FOUNDATION PLAN
 S-105 REF SCALE: 1:40



امارت اسلامی لاداکستان
 ریاست صومی اداره امور
 ملینیت مالی و اداری
 ریاست طرح و پروژه امور ساختمانی
 امریت مهندسی

Tel: 0202143082 Website: www.aop.gov.af




Designed by:	Mutasim Billah Jarar	Submission No.:		Date:
Drawn by:	Mutasim Billah Jarar	(Signature)	For Construction	1403/04/15
Checked By Head of Department:	Noorulhuda Haqqani	(Signature)	(Signature)	
Approved by Visa Committee:	M. Musa Essazai	(Signature)	(Signature)	

Contract No.:	
Contract Date:	
Fiscal Year:	1403/1445
Drawn Code:	SDCB
Paper Size:	A3
Plot Date:	1403/04/09
Scale:	1:40

SERVICES DIRECTORATE COMPLEX BUILDING AOP KABUL PROVINCE, AFGHANISTAN
POWER PLANT BUILDING
BOT-(Y-DIRECTION) REINFORCEMENT FOUNDATION PLAN

Sheet Reference Number
S-105

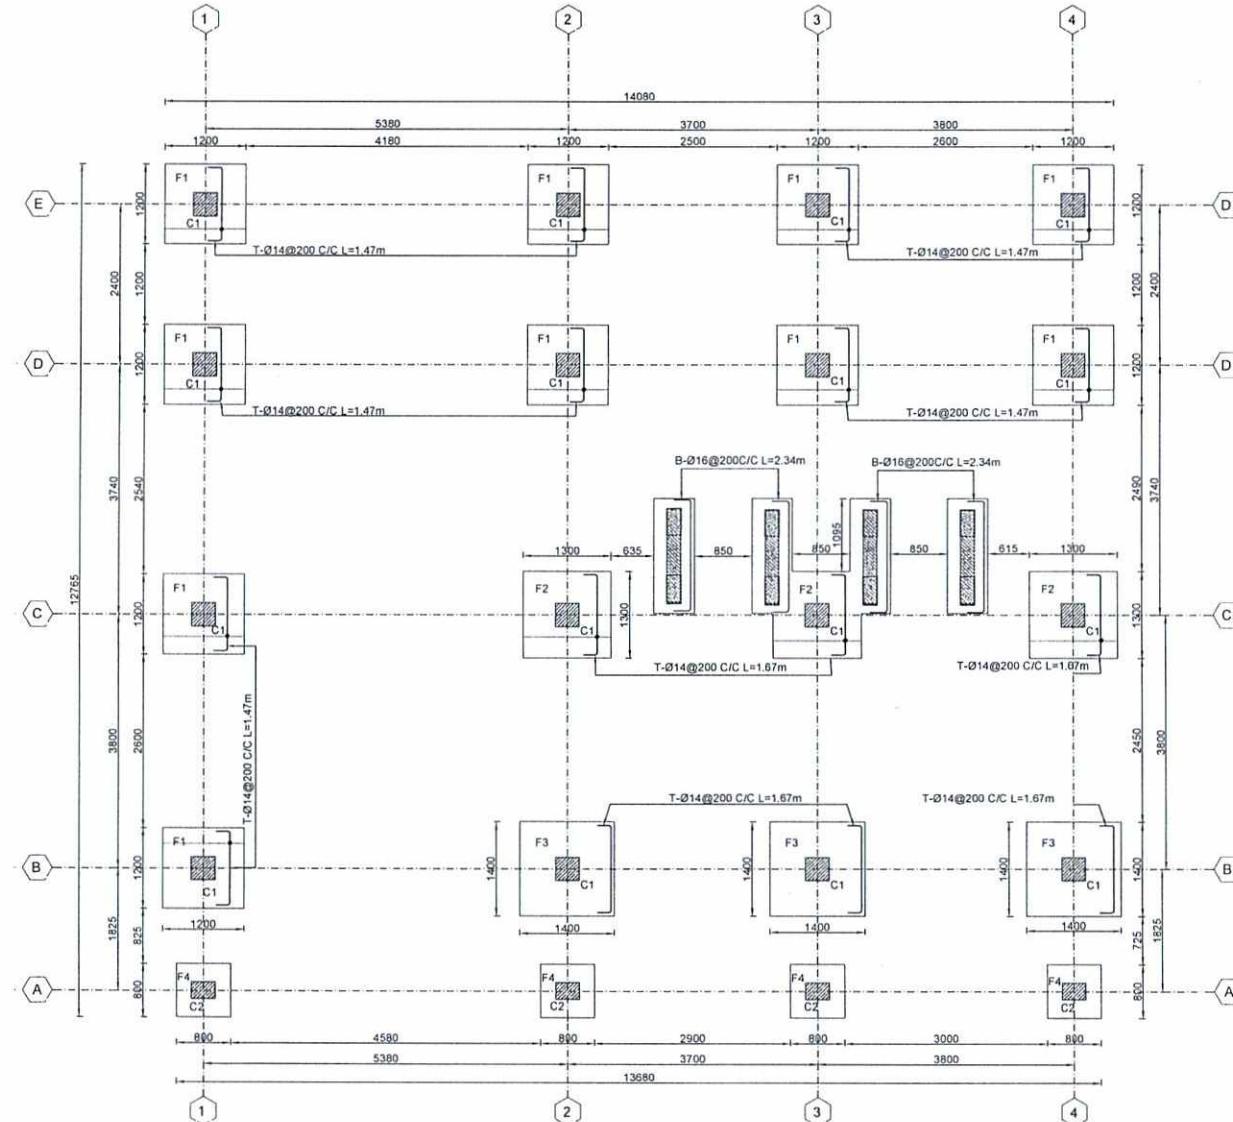

01 | TOP-(Y-DIRECTION) REINFORCEMENT FOUNDATION PLAN
S-106 | REF: SCALE- 1:40



امارت اسلامی الغافصان
ریاست صوری نایر امور
مادرست مالی و ناداری
ریاست طرح و پروژاون امور ساختهای
امرت مهندسی
Tel: 0202143082 Website: www.aop.gov.af

Designed by:	Mutasim Billah Jarar	Submission Description:	Date:
Drawn by:	Mutasim Billah Jarar	No.	
Checked By Head of Department:	Noorulhuda Haqqani	(01) For Construction	1403/04/15
Approved by Visa Committee:	M.Musa Essazai	(02)	
		(03)	
		(04)	
		(05)	
		(06)	

SERVICES DIRECTORATE COMPLEX BUILDING
AOP
KABUL PROVINCE, AFGHANISTAN
POWER PLANT BUILDING
TOP-(Y-DIRECTION) REINFORCEMENT FOUNDATION PLAN

Sheet Reference Number
S-106


NOTE :
1. ALL DIMENSIONS ARE IN MILLIMETER UNLESS OTHERWISE NOTED.
2. GRADE OF REBAR = fy = 60 KSI = 4180 Kg/cm²
3. GRADE OF REINFORCED CONC. , fc = 4000 psi = 280 Kg/cm²

01 | STONEMASONRY LAYOUTPLAN
S-107 | REF: SCALE- 1:40



امارت اسلامی افغانستان
ریاست عمومی اداره امور
معاونت مالی و اداری
ریاست طرح و دوستیابی امور ساختهای
آریست مهندسی

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NOTE :
 1. ALL DIMENSIONS ARE IN MILLIMETER
UNLESS OTHERWISE NOTED.
 2. GRADE OF REBAR = fy = 60 Ksi = 4180 Kg/cm²
 3. GRADE OF REINFORCED CONC. = fc' = 4000 ps
 = 280 Kg/cm²

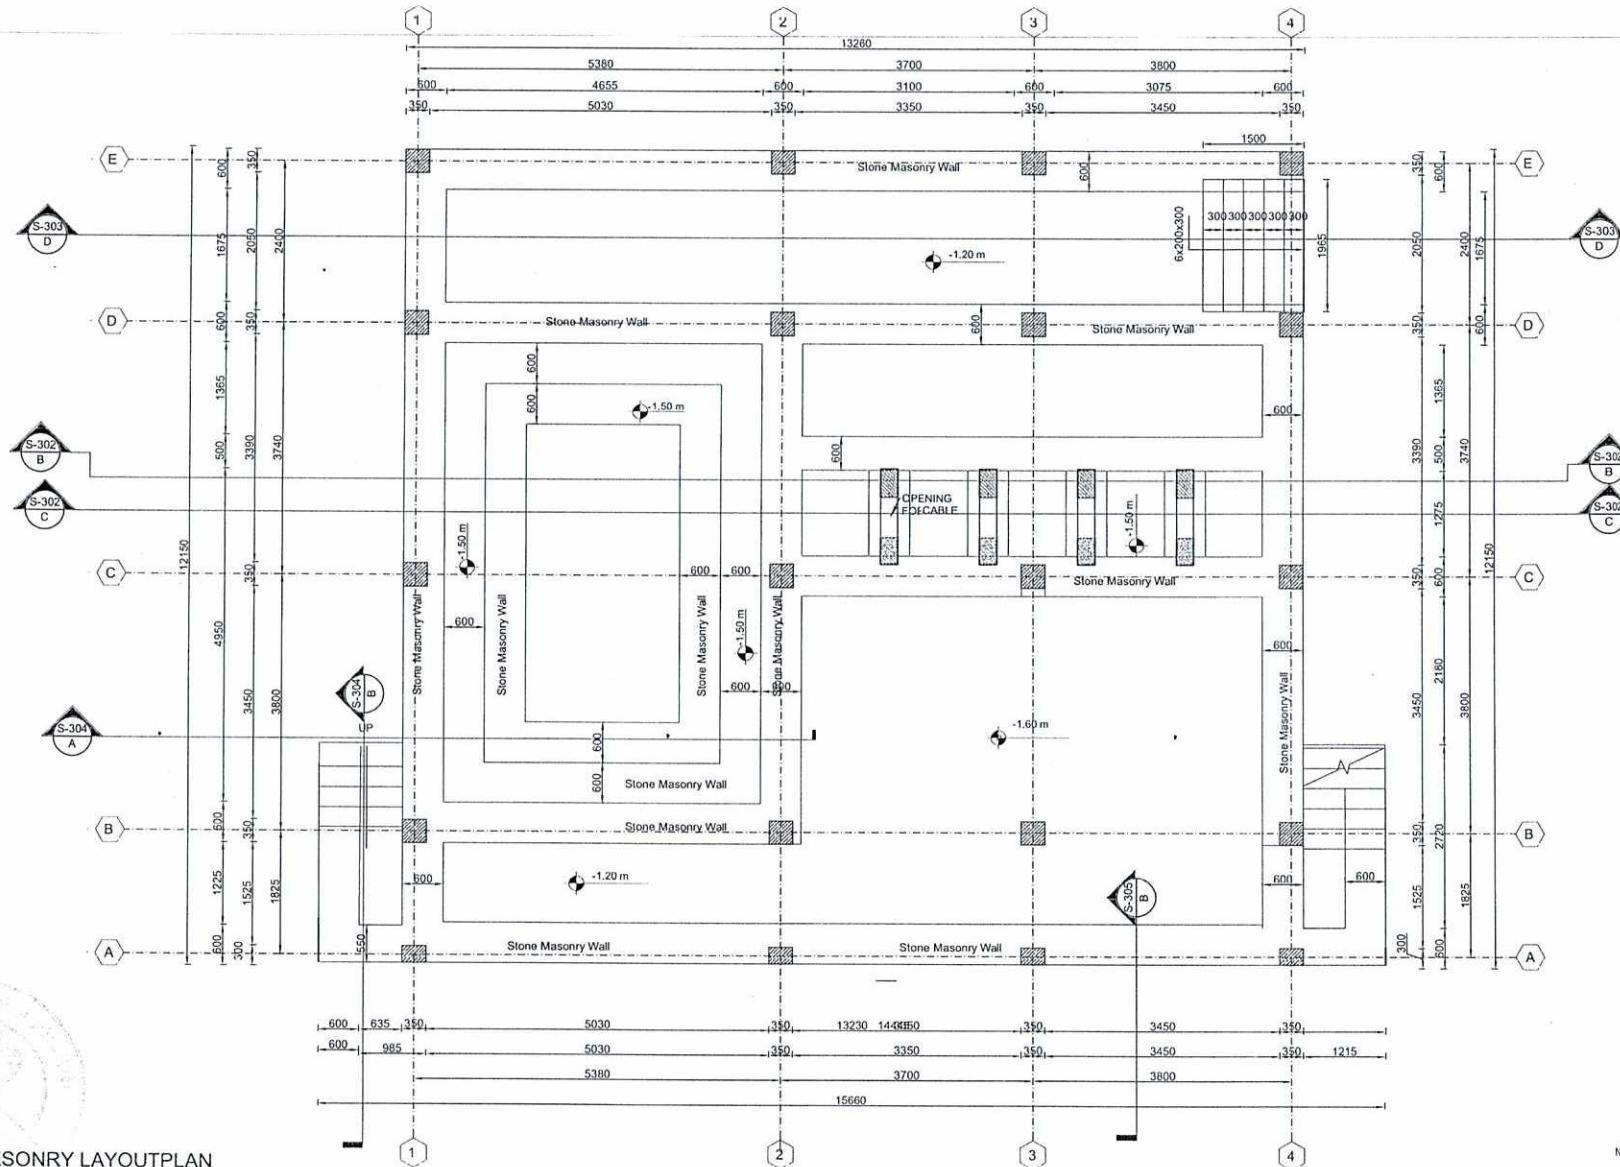
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Drawn by:	Mutasim Billah Jarar	Signature
Checked By Head of Department :	Noorulhuda Haqani	Signature
Approved by Visa Committee:	M.Musa Essazai	Signature

No.	Submission Description:	Date:
(01)	For Construction	1403/04/15
(02)		
(03)		
(04)		
(05)		

Contract No:	
Contract Date:	1403/1445
Fiscal Year:	1403/1445
Drawn Code:	SDCB
Paper Size:	A3
Plot Date:	1403/04/09
Scale:	1:00

SERVICES DIRECTORATE COMPLEX BUILDING
AOP
KABUL PROVINCE, AFGHANISTAN
POWER PLANT BUILDING
STONEMASONRY LAYOUT PLAN

Sheet Reference Number
S-107

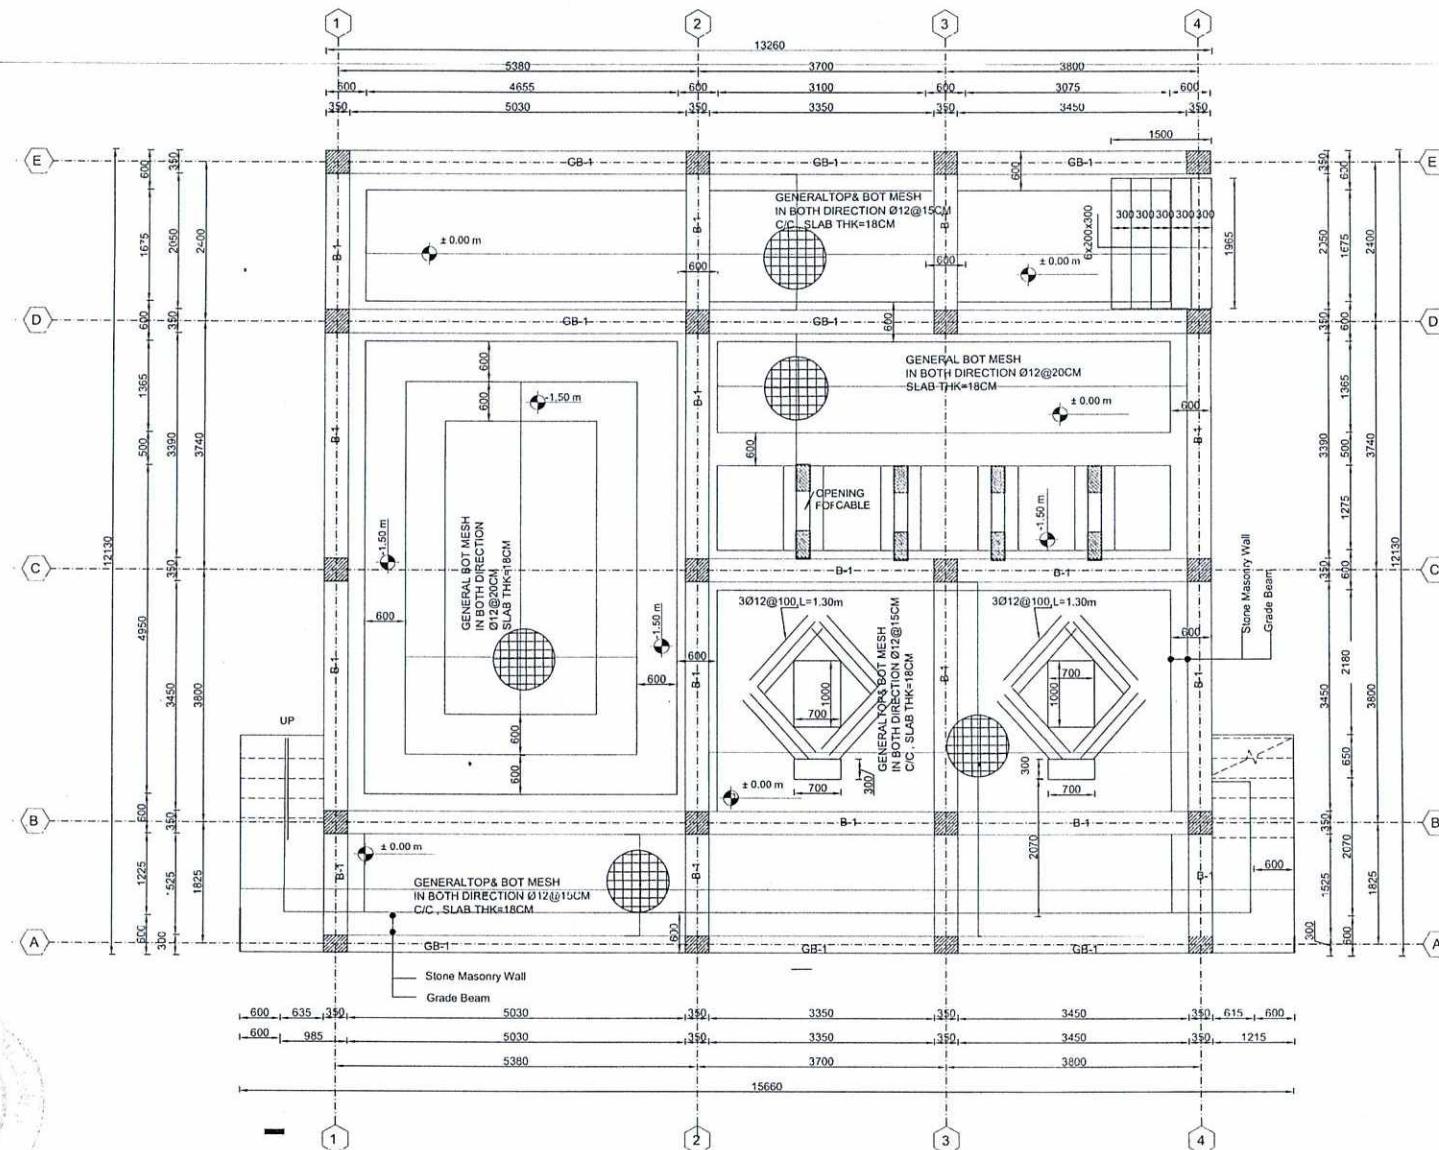

01 | SLAB ON GRADE AND GRADE BEAM PLAN
S-108 REF: SCALE- 1:40

NOTE:

1. ALL DIMENSIONS ARE IN MILLIMETER UNLESS OTHERWISE NOTED.
2. GRADE OF REBAR = $f_y = 60$ ksi = 4180 kg/cm 2
3. GRADE OF REINFORCED CONC. = $f'_c = 4000$ psi = 280 kg/cm 2



- امارت اسلامی الفتاوی
- رویاست عمومی اداره امور معاونیت مالی و اداری
- پایاست طرح و دیزاین امور ساخته‌مانی
- امروزت مهندسی

Tel: 0202143082 Website: www.aop.gov.au

Designed by:	Mutasim Bilal Jarar		No.	Submission Description:	Date:
Drawn by:	Mutasim Bilal Jarar		<input checked="" type="checkbox"/>	For Construction	1403/04
Checked By Head of Department:	Noorulhuda Haqani		<input type="checkbox"/>	02	
Approved by Visa Committee:	M.Musa Essazai		<input type="checkbox"/>	03	
			<input type="checkbox"/>	04	
		<input type="checkbox"/>	05		


Contract No:	
Contract Date:	
Fiscal Year:	1403/1445
Drawn Code:	SDCB
Paper Size:	A3
Plot Date:	1403/04/09
Scale:	1:00

SERVICES DIRECTORATE COMPLEX BUILDING
AOP
KABUL PROVINCE , AFGHANISTAN

POWER PLANT BUILDING

SLAB ON GRADE AND GRADE E

Sheet
Reference
Number

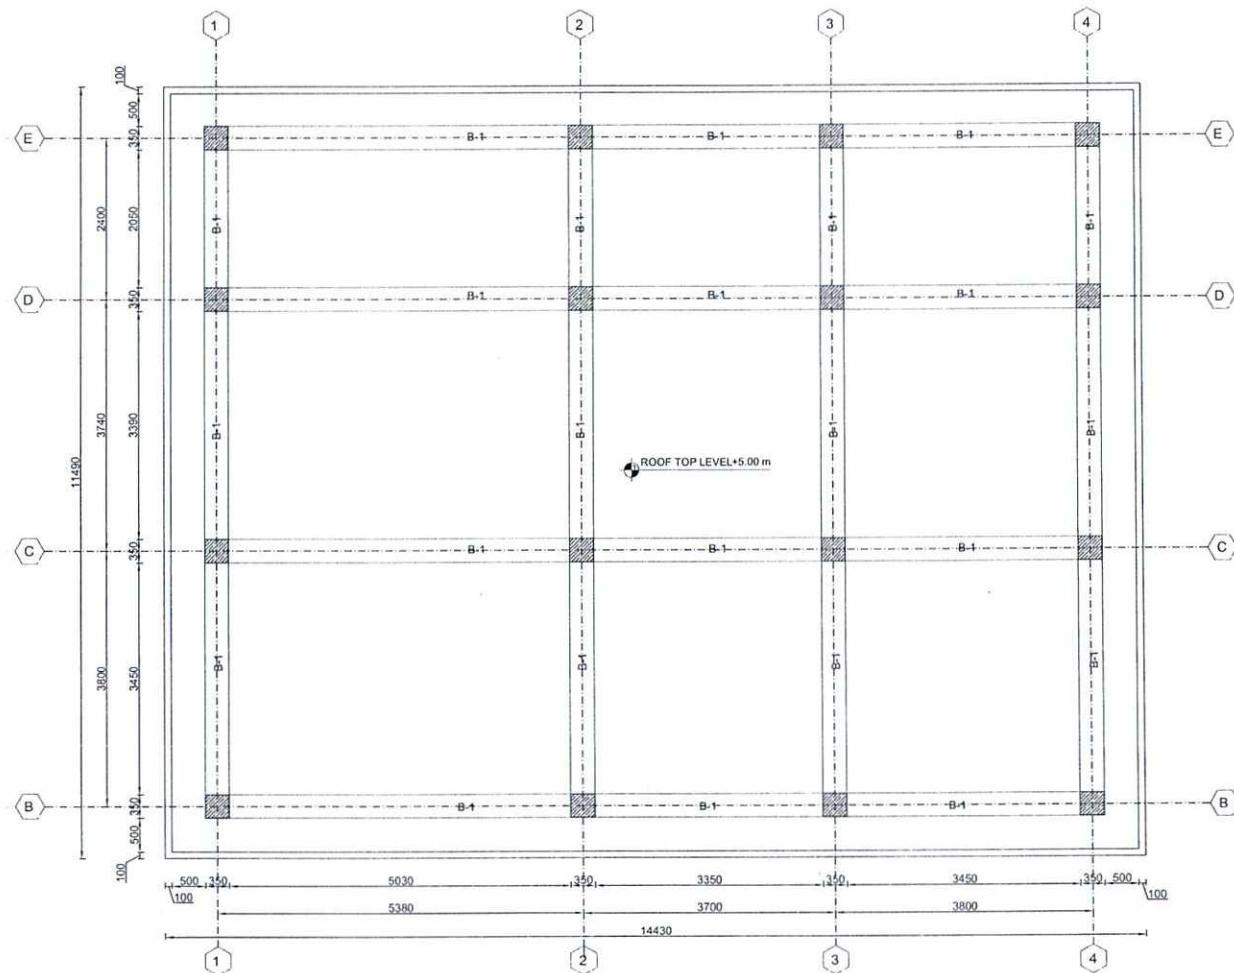

01 | BEAM PLAN
S-108 | REF: SCALE-1:40



امانت اسلامی افغانستان
رئیسیت عمومی اداره امور
ملوکیت مالی و اداری
ریاست طرح و پیزاین امور ساختهای
امروز مهندسی

Tel: 0202143082 Website: www.aop.gov.af

Designed by:	Mutasim Billah Jarar	No.	Submission Description:	Date:
Drawn by:	Mutasim Billah Jarar	01	For Construction	1403/04/15
Checked by Head of Department:	Noorulhuda Haqani	02		
Approved by Visa Committee:	M.Musa Essazai	03		


No.	Submission Description:	Date:
01	For Construction	1403/04/15
02		
03		
04		
05		

Contract No:	
Contract Date:	
Fiscal Year:	1403/1445
Drawn Code:	SDCB
Paper Size:	A3
Plot Date:	1403/04/09
Scale:	1:100

SERVICES DIRECTORATE COMPLEX BUILDING
AOP
KABUL PROVINCE, AFGHANISTAN
POWER PLANT BUILDING
BEAM PLAN

Sheet Reference Number
S-109

NOTE:
 1. ALL DIMENSIONS ARE IN MILLIMETER
UNLESS OTHERWISE NOTED.
 2. GRADE OF REBAR = fy= 60 ksi = 4180 Kg/cm²
 3. GRADE OF REINFORCED CONC. = fc' = 4000 psi
 4. 280 Kg/cm²

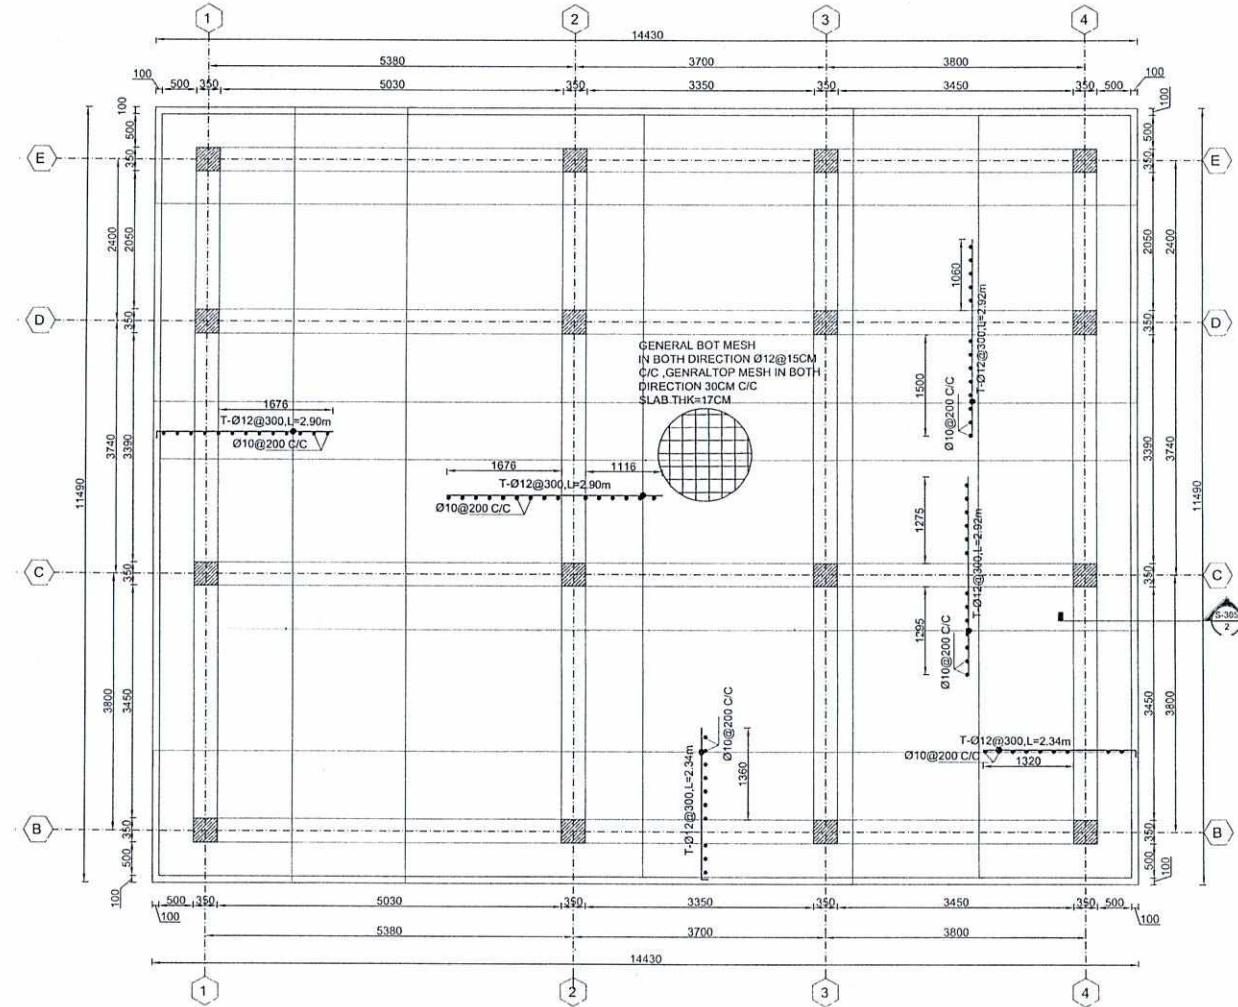

01 | SLAB RENFORCEMENT PLAN
S-109 | REF: SCALE- 1:40



امارت اسلامی افغانستان
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ریاست طرق و پیزاین امور ساختهای
امربت مهندسی

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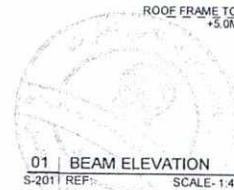
NOTE:
 1. ALL DIMENSIONS ARE IN MILLIMETER
UNLESS OTHERWISE NOTED.
 2. GRADE OF REBAR = fy = 60 Ksi = 4180 Kg/cm²
 3. GRADE OF REINFORCED CONC. = fc = 4000 psi
= 280 Kg/cm²

Designed by:	Mutasim Bilal Jarar	Submission Description:	For Construction	Date:	1403/04/15
Drawn by:	Mutasim Bilal Jarar				
Checked By Head of Department:	Noorulhuda Haqani				
Approved by Visa Committee:	M.Musa Essazai				

Contract No:	
Contract Date:	
Fiscal Year:	1403/1445
Drawn Code:	SDCB
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Plot Date:	1403/04/09
Scale:	1:100


SERVICES DIRECTORATE COMPLEX BUILDING
AOP
KABUL PROVINCE, AFGHANISTAN
POWER PLANT BUILDING
SLAB RENFORCEMENT PLAN

Sheet Reference Number
S-110



01 | BEAM ELEVATION
S-201 REF: SCALE-1:40

ROOF FRAME TOP ELEVATION
+5.0M LVL

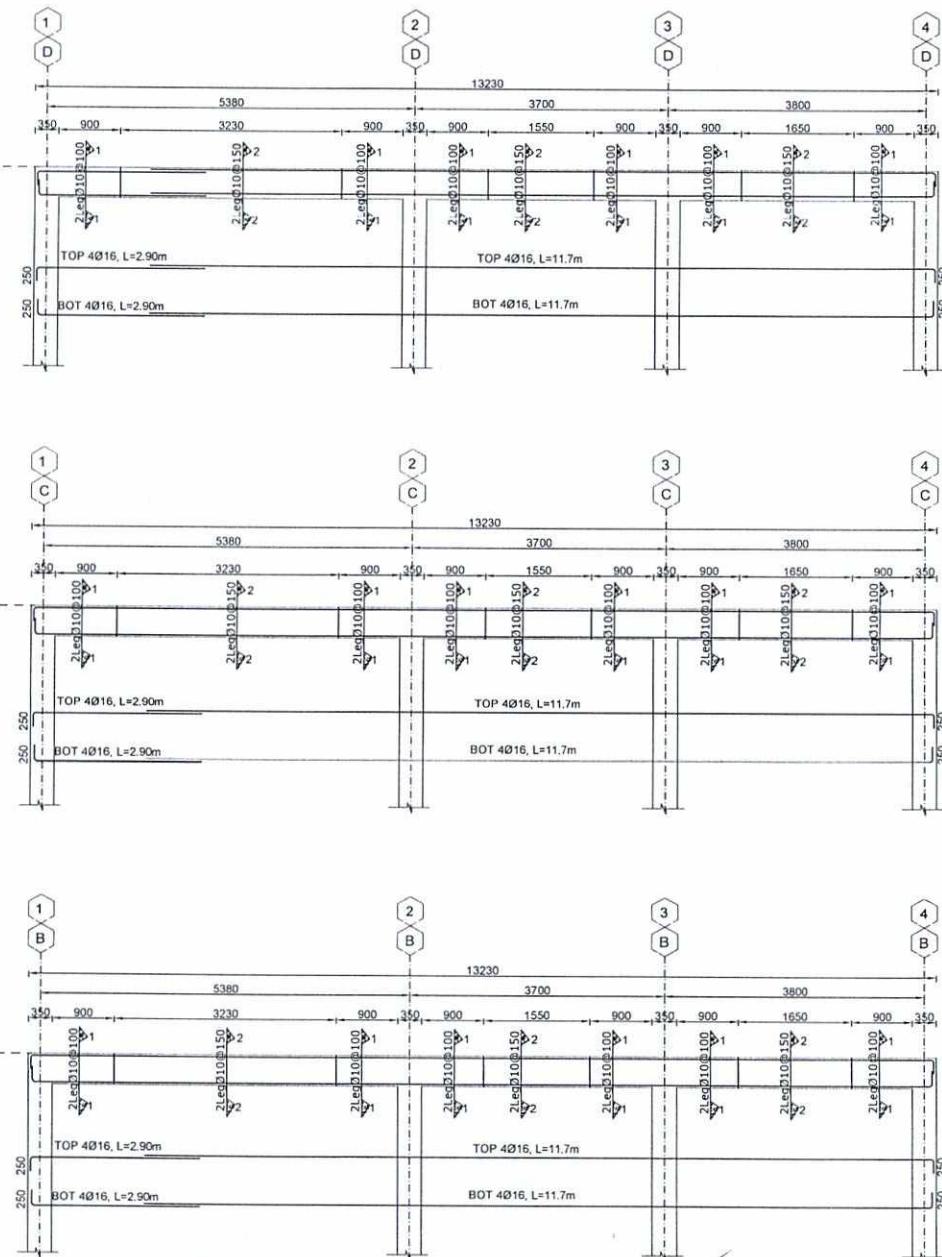

امارت اسلامی لغمانستان
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ریاست طرح و پروژه امور ساخته ای
افغانستان
Tel: 0202143082 Website: www.aop.gov.af

Designed by:

Mutasim Billah Jarar

Drawn by:

Mutasim Billah Jarar

Checked By Head of Department

Noorulhuda Haqani

Approved by Visa Committee:

M. Musa Essazai

No.

Submission Description

Date

(01) For Construction

1403/04/15

Contract No:

(01)

(02)

(03)

(04)

(05)

Contract Date

Fiscal Year:

Drawn Code:

Paper Size:

Plot Date:

Scale:


1403/1445

SDCB


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1403/04/09

1.00

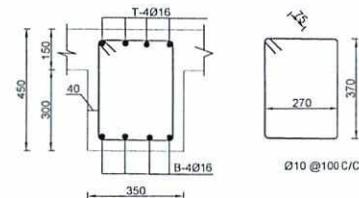

02 | BEAM SECTION(1-1)
S-201 REF: SCALE-1:10

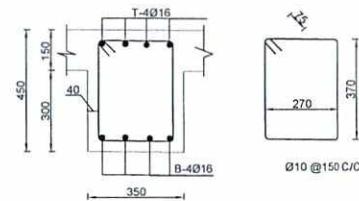

03 | BEAM SECTION(2-2)
S-201 REF: SCALE-1:10


NOTE:
1. ALL DIMENSIONS ARE IN MILLIMETER UNLESS OTHERWISE NOTED.
2. GRADE OF REBAR = fy= 60 ksi = 4180 Kg/cm²
3. GRADE OF REINFORCED CONC. = fc' = 4000 psi = 280 kg/cm²

SERVICES DIRECTORATE COMPLEX BUILDING
AOP
KABUL PROVINCE, AFGHANISTAN
POWER PLANT BUILDING
BEAM ELEVATION AND SECTION


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S-201

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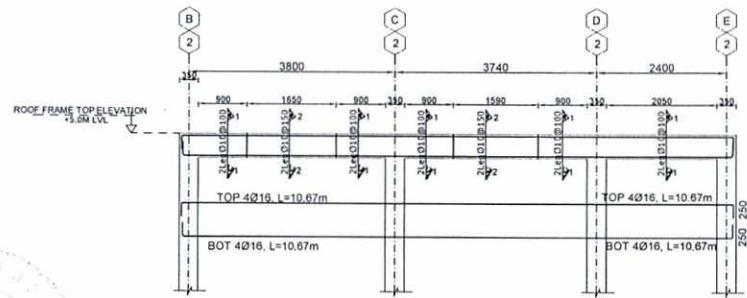
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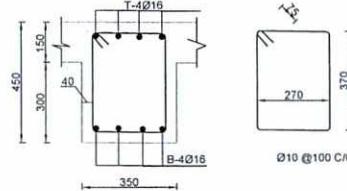
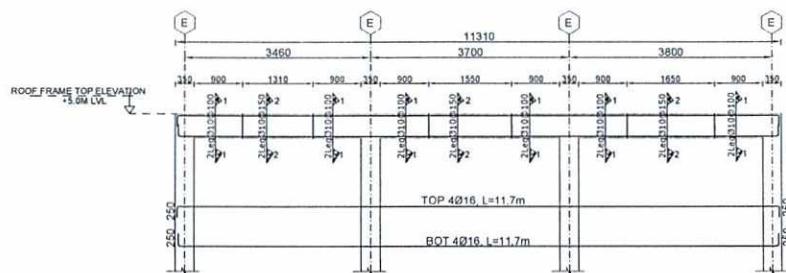
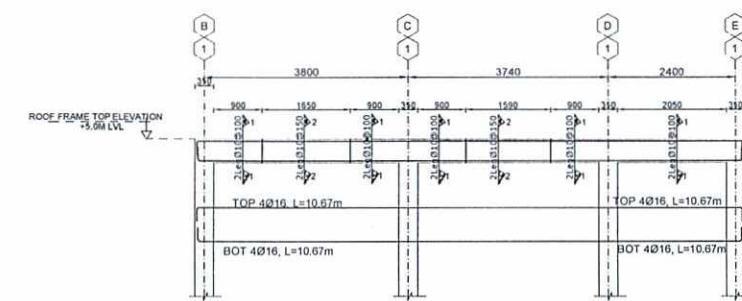


01 | BEAM ELEVATION
S-202 | REF: SCALE-1:50

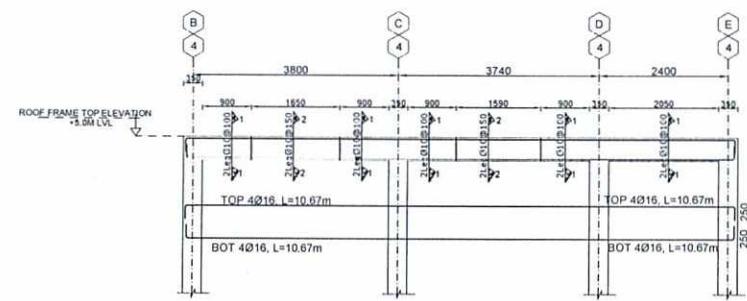


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02 | BEAM SECTION
S-202 | REF: SCALE-1:10

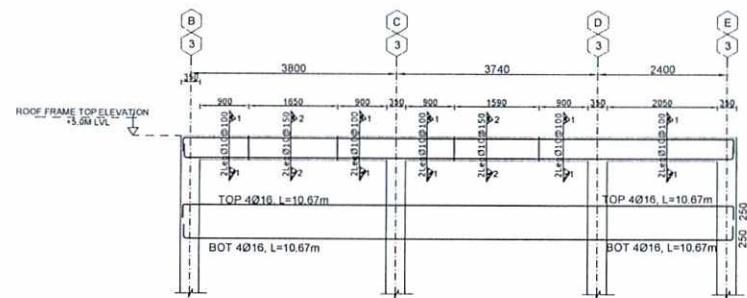

03 | BEAM SECTION
S-202 | REF: SCALE-1:10


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1. ALL DIMENSIONS ARE IN MILLIMETER
UNLESS OTHERWISE NOTED.
2. GRADE OF REBAR = fy = 60 KSI = 4160 Kg/cm²
3. GRADE OF REINFORCED CONC. = fc' = 4000 psi
= 280 Kg/cm²

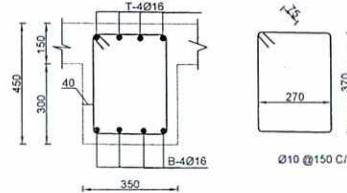SERVICES DIRECTORATE COMPLEX BUILDING
AOP
KABUL PROVINCE, AFGHANISTAN
POWER PLANT BUILDING
BEAM ELEVATION AND SECTION

Sheet Reference Number
S-202

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(05)		

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Contract Date:
Fiscal Year:
Drawn Code:
Paper Size:
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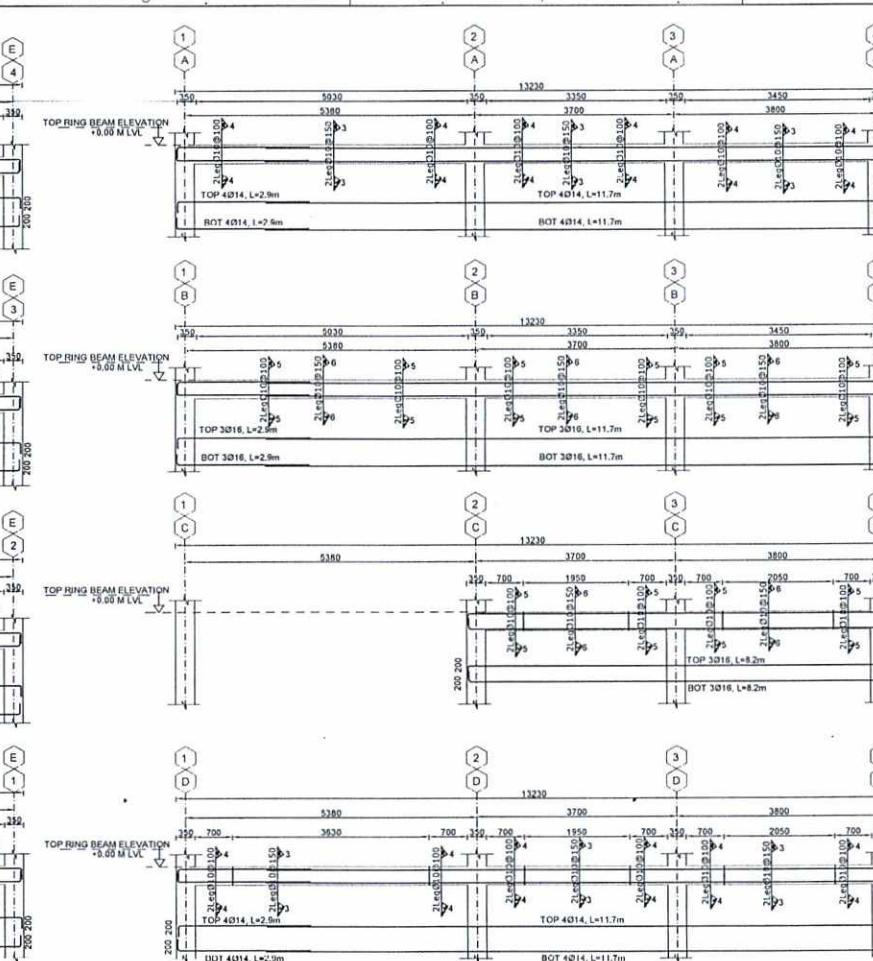


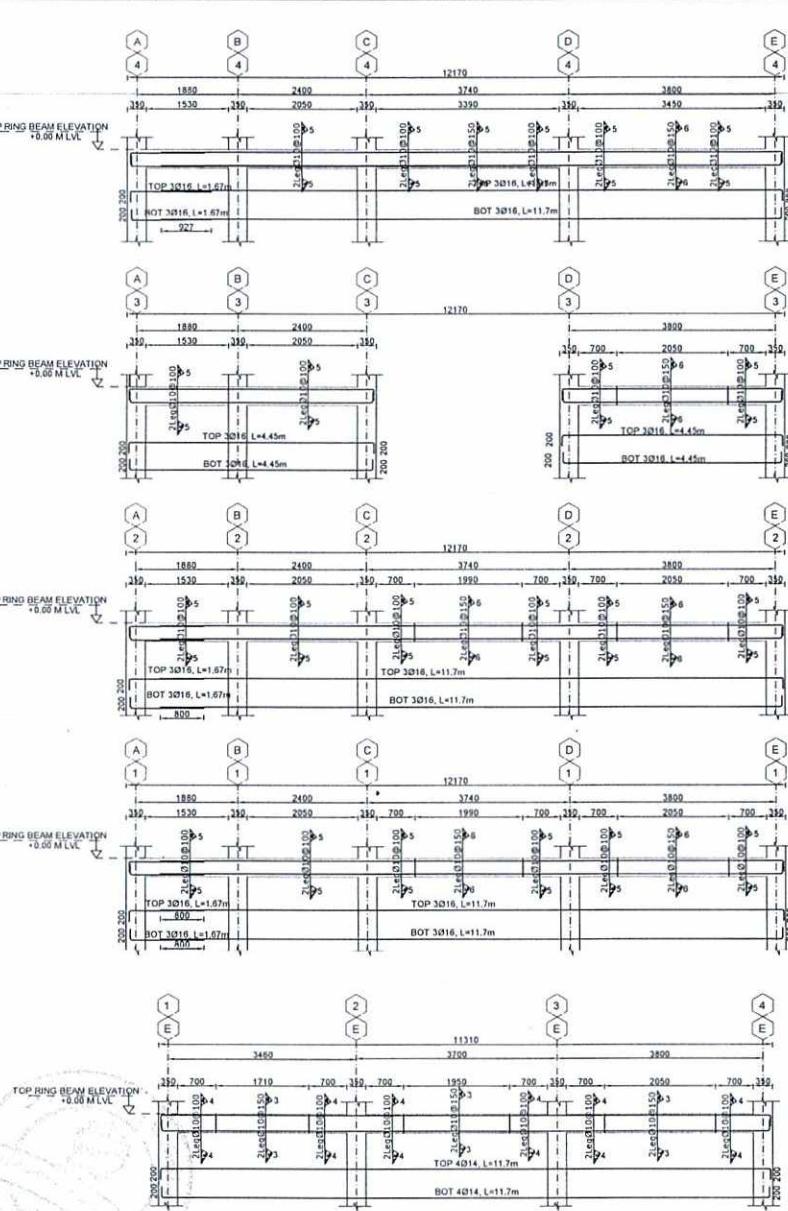01 GRADE BEAM ELEVATION
S-2031 REF: SCALE-1:50



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امرت مہندسی

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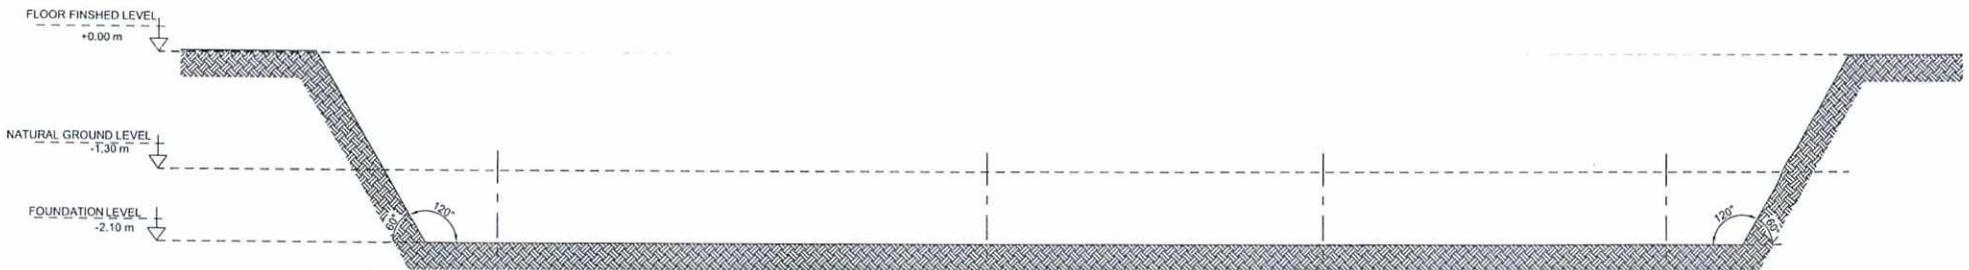
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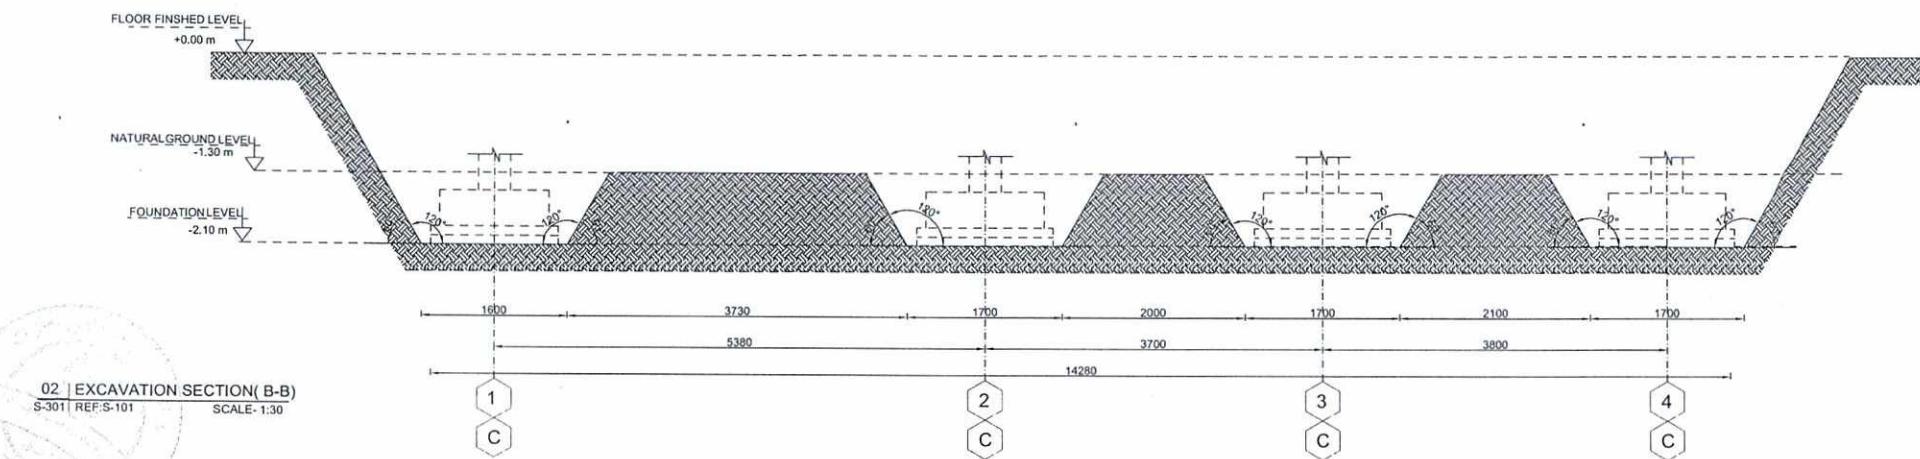
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Contract Date:
Fiscal Year: 1403/1445
Drawn Code: SDCB
Paper Size: A3
Plot Date: 1403/04/09
Scale: 1:00

SERVICES DIRECTORATE COMPLEXBUILDING
AOP
KABUL PROVINCE , AFGHANISTAN
POWER PLANT BUILDING
GRADE BEAM ELEVATION

Sheet Reference Number
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01 | EXCAVATION SECTION(A-A)
S-301 REF:S-101 SCALE-1:30



02 | EXCAVATION SECTION(B-B)
S-301 REF:S-101 SCALE-1:30



امارت اسلامی الافغانستان

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امرت مهندسی

دیوبندی

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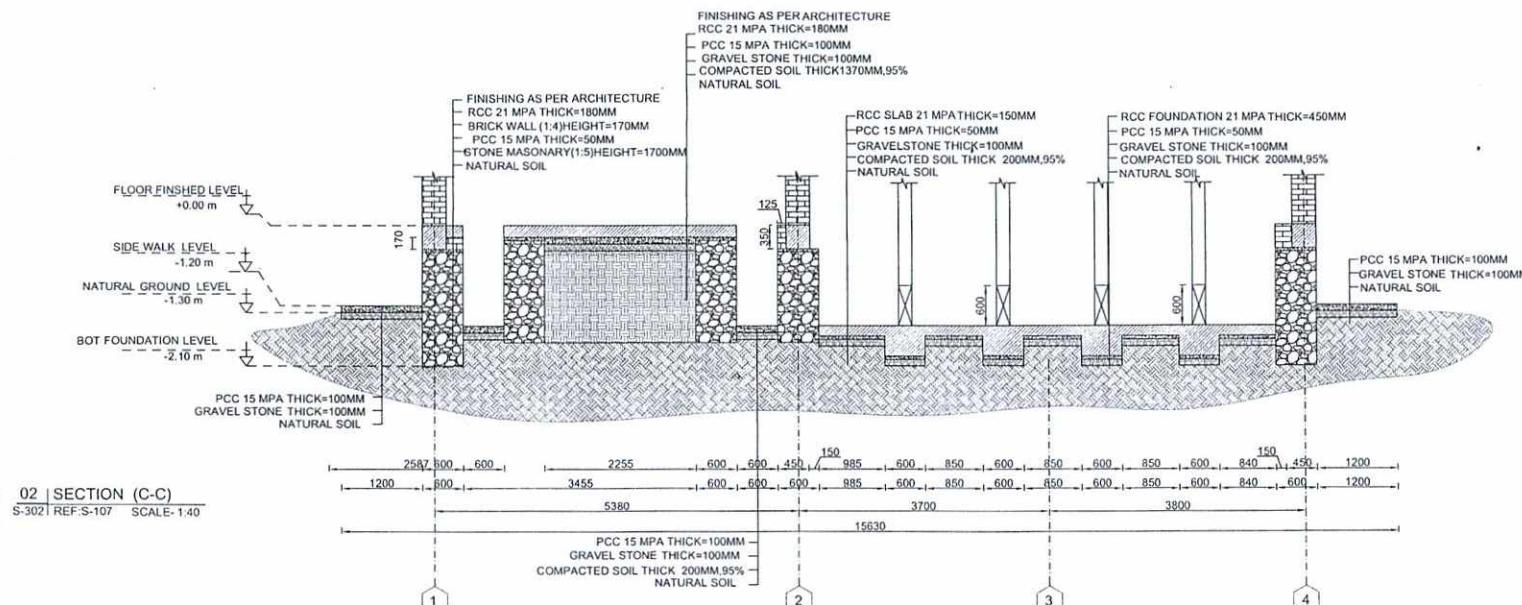
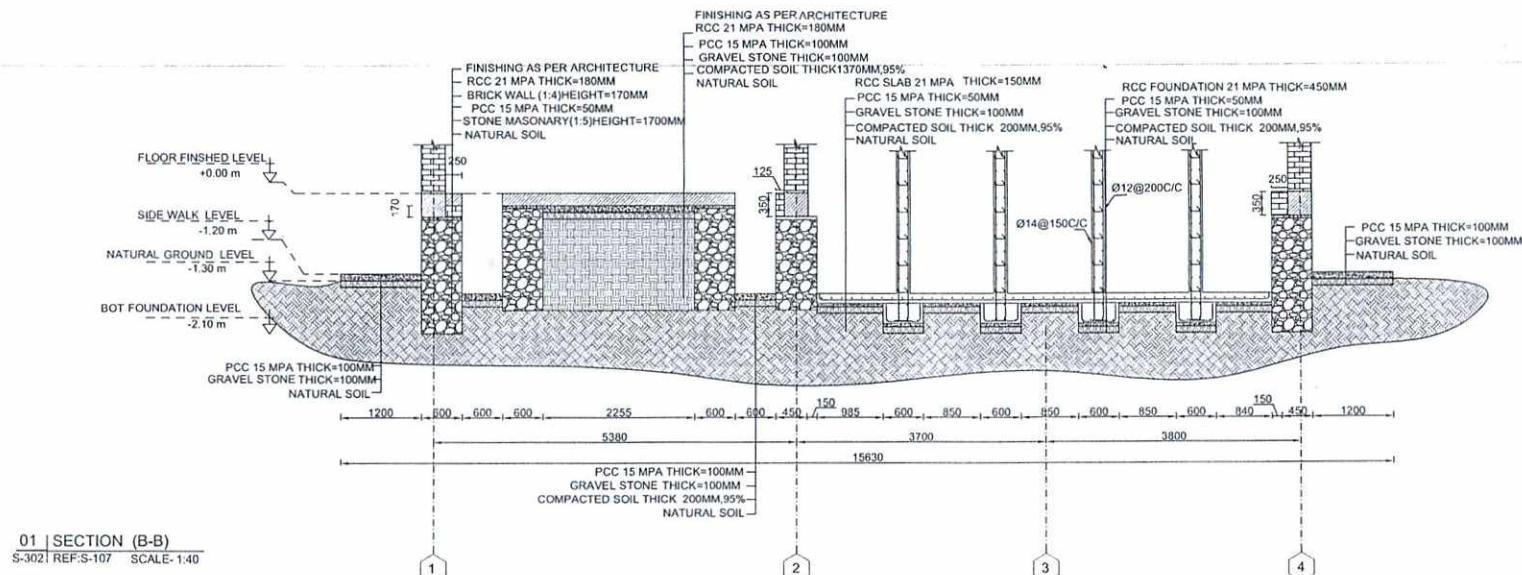
Designed by:	Mutasim Billah Jarar	
Drawn by:	Mutasim Billah Jarar	
Checked By Head of Department:	Noorulhuda Haqani	
Approved by Visa Committee:	M.Musa Essazai	

No.	Submission Description	Date
(01)	For Construction	1403/04/15
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Contract No.	
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SERVICES DIRECTORATE COMPLEX BUILDING
AOP
KABUL PROVINCE , AFGHANISTAN
POWER PLANT BUILDING
EXCAVATION SECTIONS

Sheet Reference Number
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امارت اسلامی افغانستان

ریاست جمهوری افغانستان

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وزارت امور مسکن

وزارت ترقیات

وزارت مهندسی

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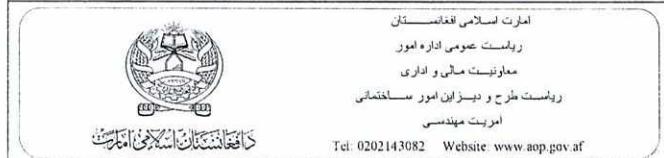
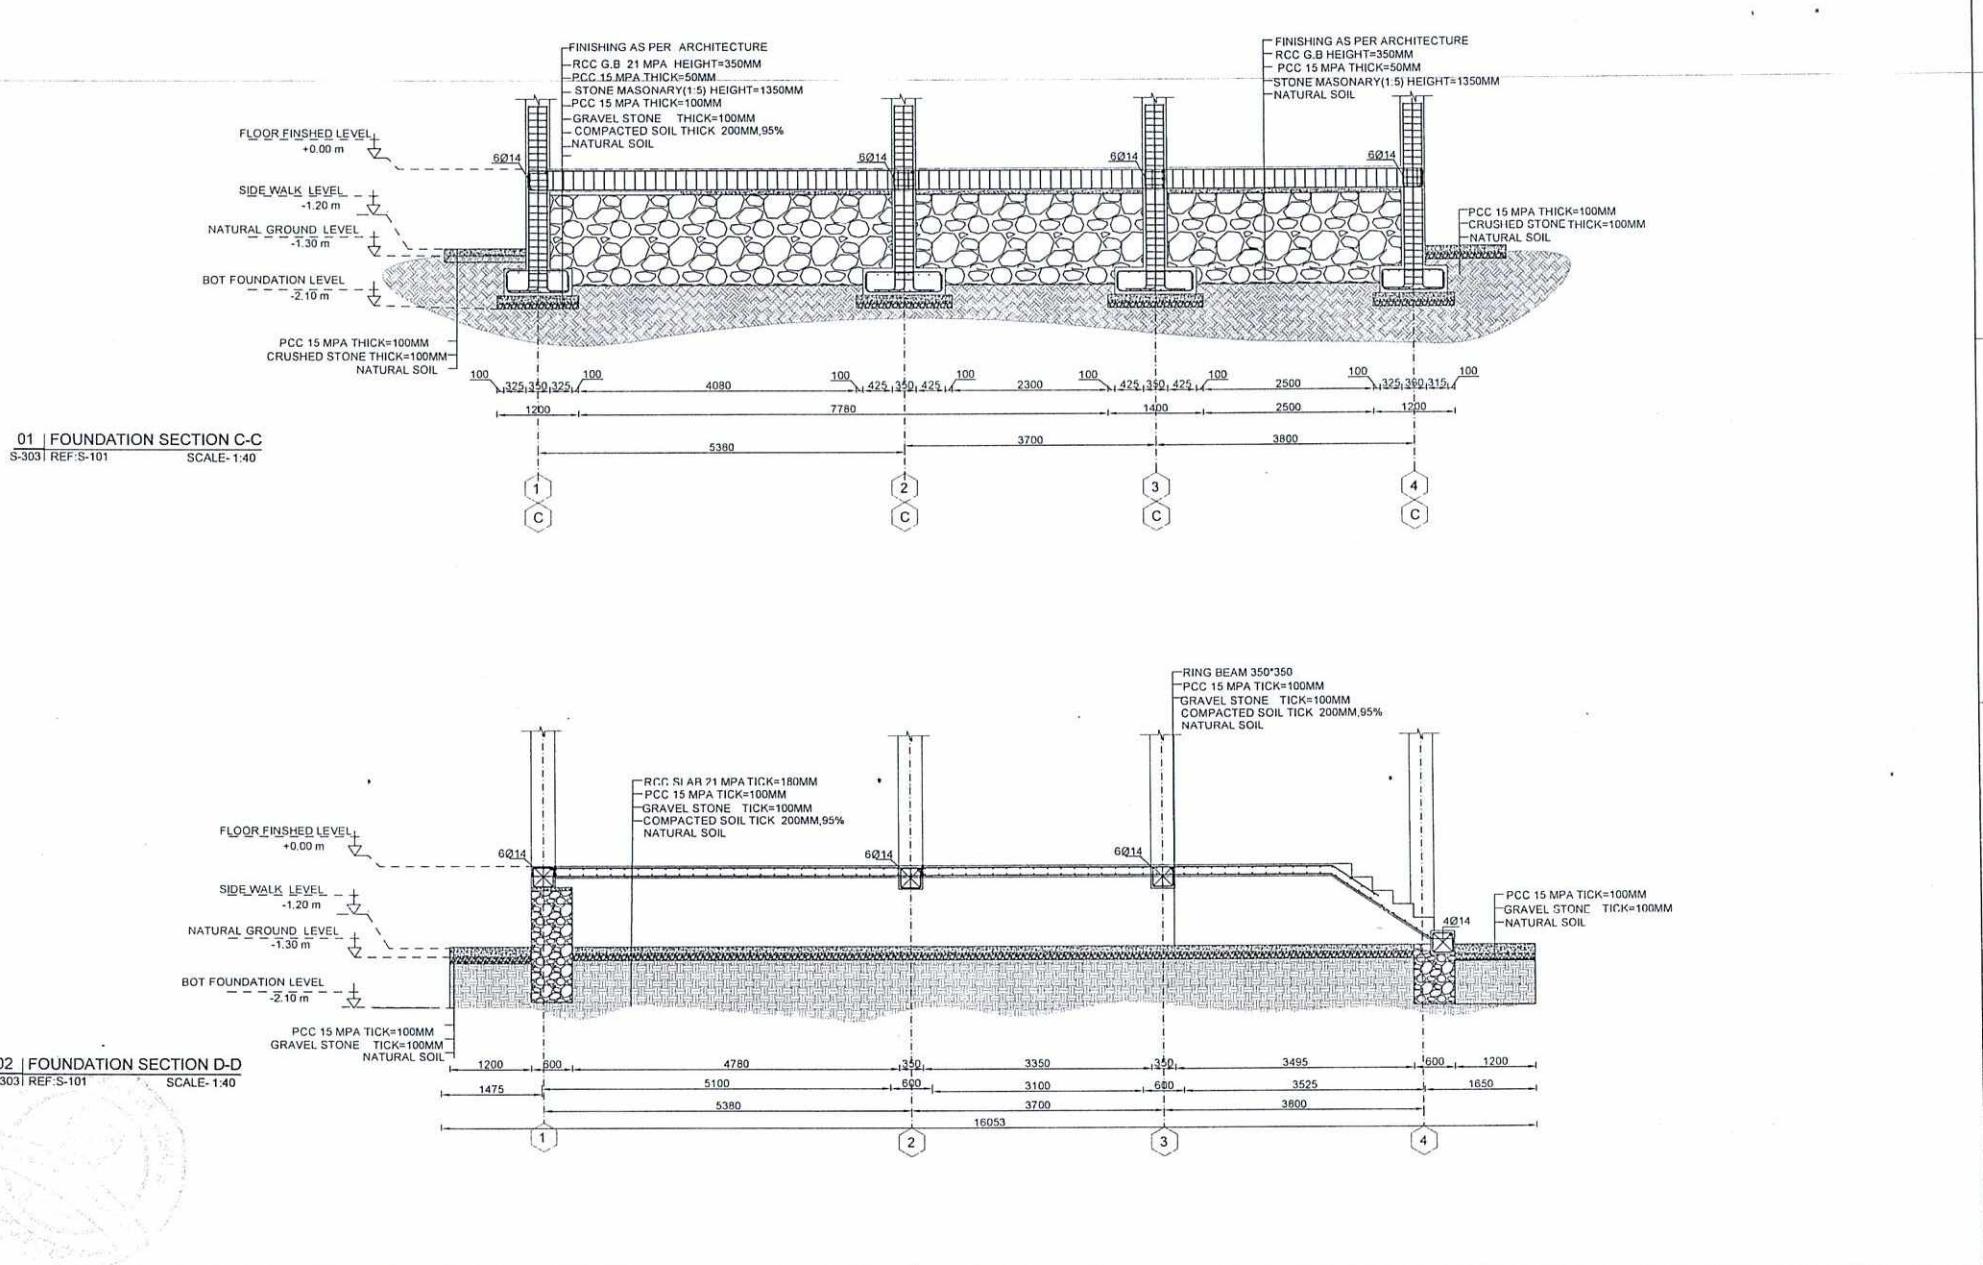
Designed by:	Mutasmil Bilal Jarar
Drawn by:	Mutasmil Bilal Jarar
Checked By Head of Department:	Noorulhuda Haqani
Approved by Visa Committee:	M.Musa Essezaai

No.	Submission Description	Date
01	For Construction	1403/04/15
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SERVICES DIRECTORATE COMPLEX BUILDING
AOP
KABUL PROVINCE , AFGHANISTAN
POWER PLANT BUILDING
SECTIONS

Sheet Reference Number
S-302









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Drawn by:	Mutasim Billah Jarar	No.	Contract No.
Checked By Head of Department:	Noorulhuda Haqani	(01) For Construction	1403/04/15
Approved by Visa Committee:	M.Musa Essazai	(02)	Contract Date:
		(03)	Fiscal Year:
		(04)	1403/1445
		(05)	Drawn Code:
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SERVICES DIRECTORATE COMPLEX BUILDING
AOP
KABUL PROVINCE , AFGHANISTAN
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FOUNDATION SECTION C-C

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S-303



امانت اسلامی افغانستان
ریاست مومی اداره امور
مکانیزم مالی و اداری
ریاست طرق و جیزین امور ساختمانی
امانت هندنس

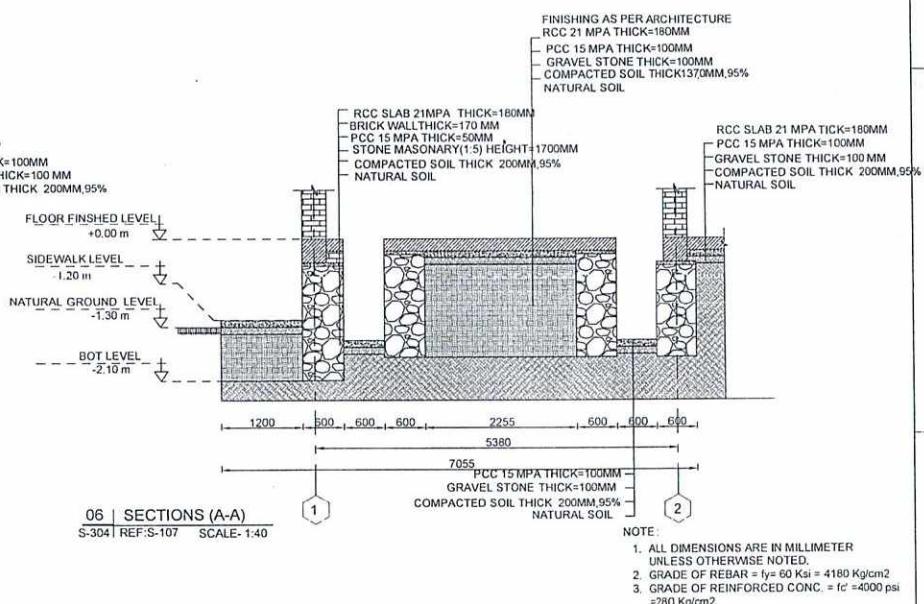
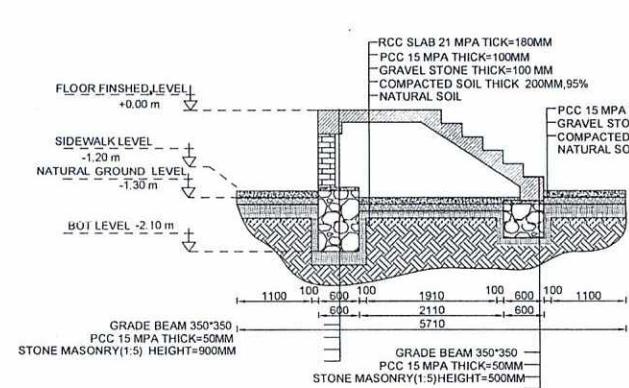
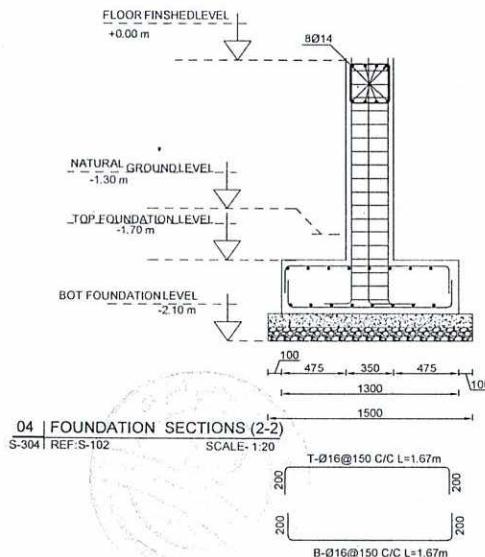
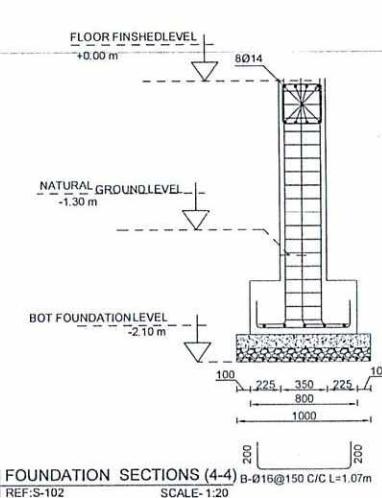
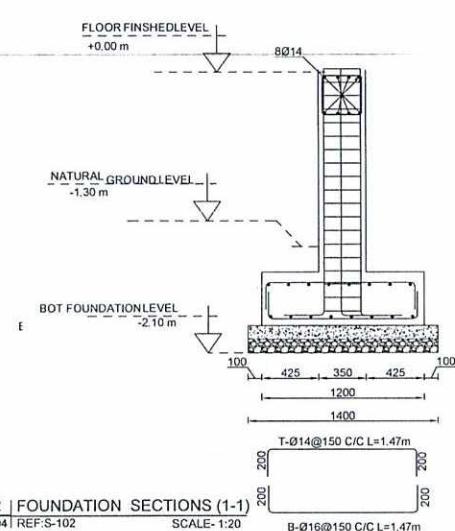
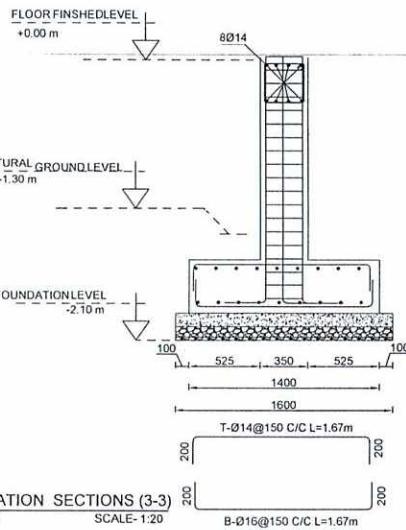
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Designed by	Mutasim Bilal Jarar	No.	Submission Description	Date
Drawn by	Mutasim Bilal Jarar	(01)	For Construction	1403/04/15
Checked By Head of Department	Noorulhuda Haqani	(02)		
Approved by Visa Committee	M.Musa Essazai	(03)		
		(04)		
		(05)		

Contract No:	
Contract Date:	
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SERVICES DIRECTORATE COMPLEX BUILDING
AOP
KABUL PROVINCE , AFGHANISTAN
POWER PLANT BUILDING
FOUNDATION SECTIONS

Sheet Reference Number
S-304



امانت اسلامی افغانستان
ریاست جمهوری افغانستان
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ریاست طرح و دیزاین لور ساخته ای
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Designed by:	Mutasim Bilal Jarar
Drawn by:	Mutasim Bilal Jarar
Checked By Head of Department:	Noorulhuda Haqani
Approved by Visa Committee:	M. Musa Essazai

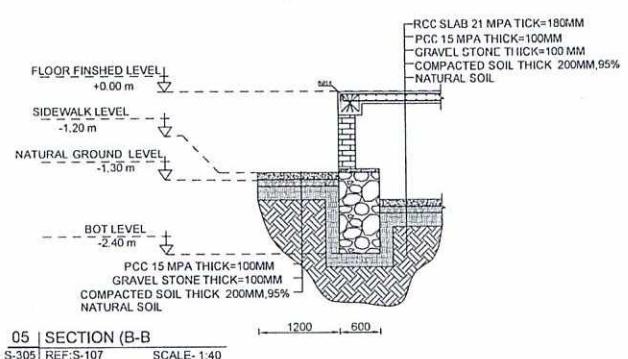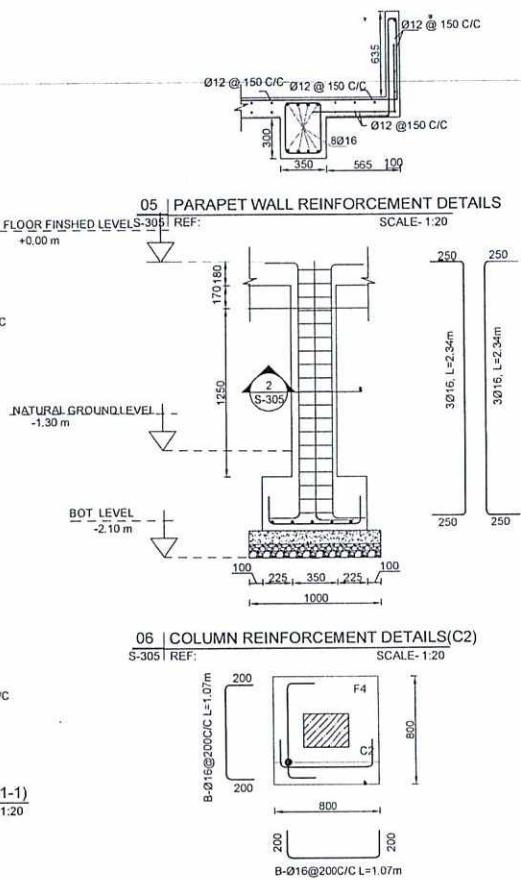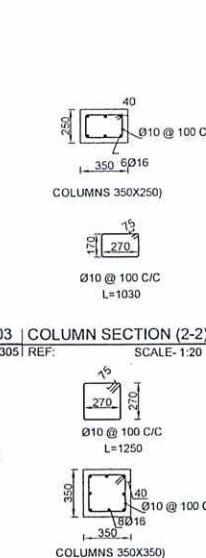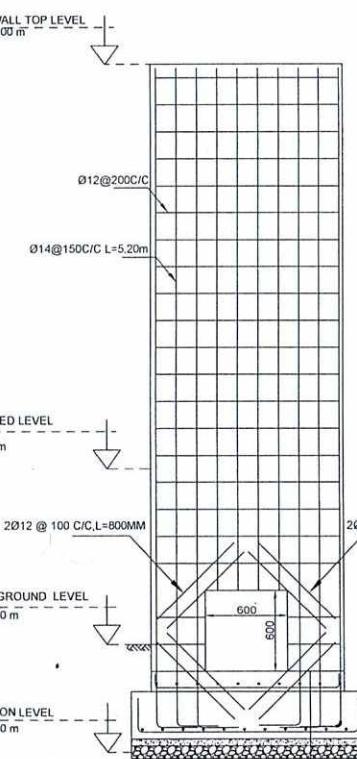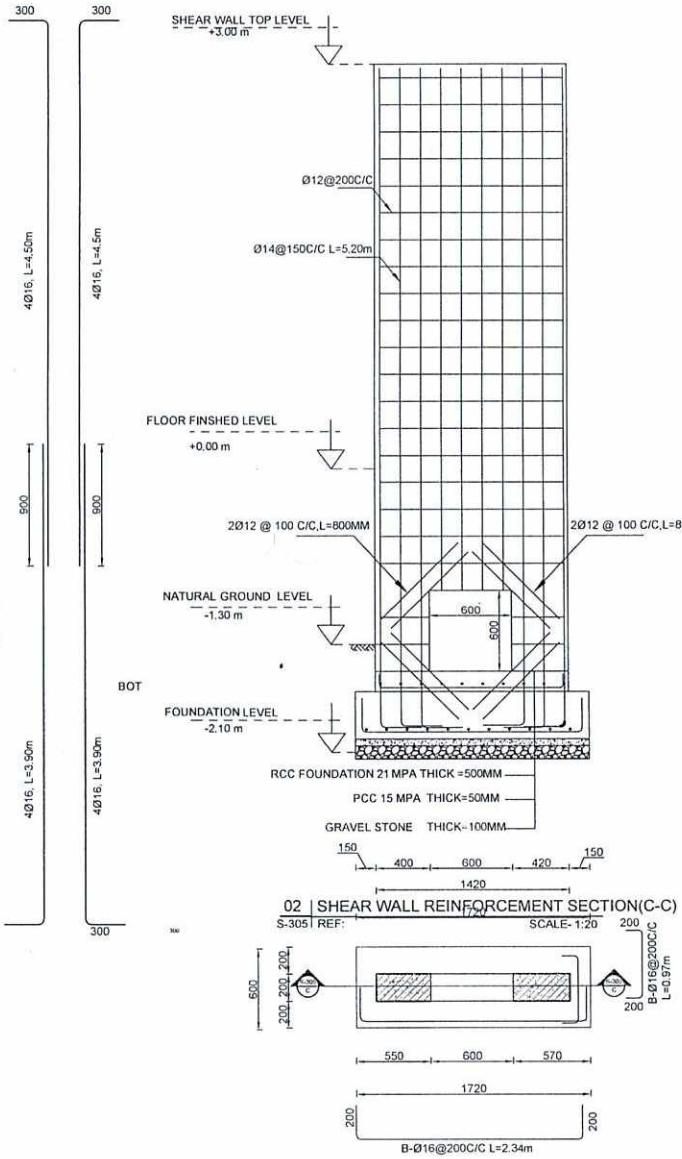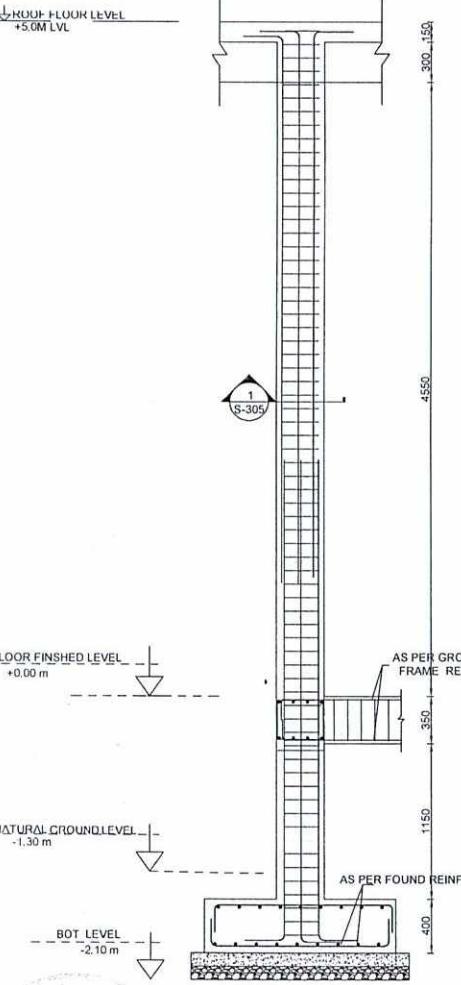No.	Submission Description:	Date
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SERVICES DIRECTORATE COMPLEX BUILDING
AOP
KABUL PROVINCE, AFGHANISTAN
POWER PLANT BUILDING
COLUMN ELEVATION AND SECTION

Sheet Reference Number
S-305



د افغانستان اسلامی امداد

امارت اسلامی افغانستان

ریاست عمومی اداره امور

معاونیت مالی و اداری

ریاست طرح و دیزاین امور ساختمانی


آمریت برق

نقشه های برق

تعمیر کمپلکس ریاست خدمات

برج برق ساحه ۵

کابل - افغانستان

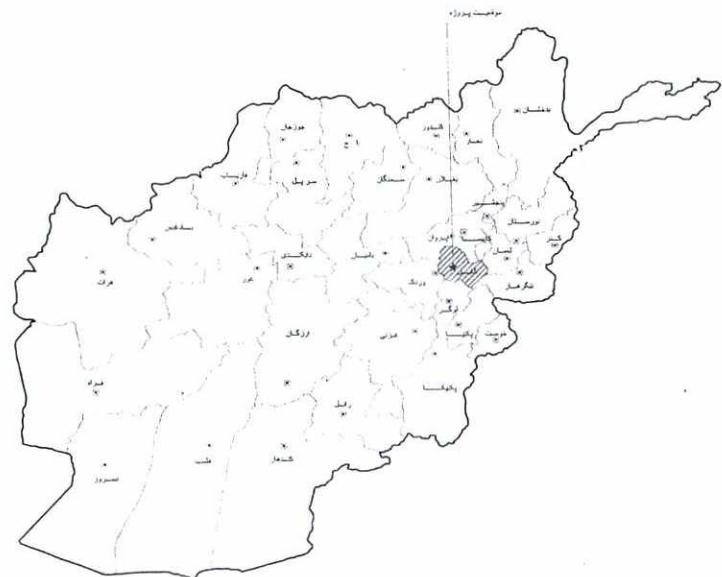

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- ۱- امانت اسلامی افغانستان
- ۲- ریاست عمومی اداره امور معاونیت مالی و اداری
- ۳- پاسخگیری مطروح و دیپلم امور ساخته‌مانی
- ۴- امریکت بریق

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Designed by:	Noor Ahmad		No. Submission Description Date (01) For Construction 1403/0 (02) (03) (04) (05)
Drawn by:	Noor Ahmad		
Checked By Head of Department	Summer Gull		
Approved by Visq Committee	Jawed Hammad		

Contract No:	
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SERVICES DIRECTORATE COMPLEX BUILDING
AOP
KABUL PROVINCE, AFGHANISTAN

POWER PLANT BUILDING
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G-001

ELECTRICAL NOTES

1. ALL WIRES SHALL BE INSTALLED INSIDE PVC CONDUITS SCHEDULE 40 CONCEALED IN WALLS, FLOOR AND CEILINGS, UNLESS OTHERWISE SPECIFIED.
2. EMERGENCY LIGHTS AND EXIT LIGHTS SHALL BE CONNECTED TO THE UN-SWITCHED PORTION OF THE AREA LIGHTING BRANCH CIRCUIT.
3. ALL WORKS, AND INSTALLATIONS RELATED TO THE ELECTRICAL SYSTEMS SHALL BE DONE IN COORDINATION WITH THE PROJECT ELECTRICAL ENGINEER.
4. ALL ELECTRICAL DEVICES AND EQUIPMENT TO BE PROVIDED SHALL BE 220/380V, 50 Hz.
5. ALL ELECTRICAL WORK SHALL BE DONE IN ACCORDANCE WITH THE NATIONAL ELECTRICAL CODE (NEC) AND ALL LOCAL CODES HAVING JURISDICTION. ALL EQUIPMENT, DEVICES, AND MATERIAL SHALL BE IEC REQUIREMENT MANUFACTURED.
6. ELECTRICAL PLANS ARE DIAGRAMMATIC, DO NOT SCALE DRAWINGS.
7. SEE REFLECTED CEILING PLAN FOR EXACT LOCATION OF LIGHT FIXTURES.
8. LIGHTING FIXTURES INSTALLED IN SUSPENDED CEILINGS SHALL BE SUPPORTED DIRECTLY FROM THE BUILDING STRUCTURE.
9. ALL EMPTY CONDUIT RUNS IN EXCESS OF 80 CM. SHALL BE PROVIDED WITH A PULL WIRE OF FISH TAPE/CORD.
10. OPENINGS IN EXISTING BUILDING STRUCTURE FOR PASSAGE OF CONDUITS/CABLES SHALL NOT BE CUT UNTIL THE CONTRACTOR HAS ASKED FOR AND RECEIVED WRITTEN APPROVAL FROM THE ARCHITECT.
11. THE LIGHTING FIXTURES SHALL BE FURNISHED AND INSTALLED COMPLETELY WITH ALL ACCESSORIES (INCLUDING LAMPS) BY THE ELECTRICAL CONTRACTOR.
12. CONDUCTORS SHALL BE INSTALLED CONTINUOUS BETWEEN DEVICES, WITH SPLICES LOCATED ONLY IN JUNCTION BOXES OR IN CABINETS. CONDUCTORS SHALL BE OF SUFFICIENT LENGTH TO REACH THE FARDEST TERMINAL IN PANELS.
13. PROVIDE AN UPDATED TYPE WRITTEN PANEL DIRECTORY IN EACH PANEL AFTER COMPLETION OF WORK.
14. PROVIDE CORD AND PLUG TO ALL ELECTRIC WATER HEATER AND TO PROVIDE RECEPTACLE TO MATCH THE SUPPLIED CORD AND PLUG.
15. COLOR CODES FOR THE PROJECT WILL BE IEC AND MUST BE COMPLIED WITH IN ELECTRICITY INSTALLATION.
16. MATERIAL AND EQUIPMENT INSTALLED UNDER THIS CONTRACT SHALL BE FOR THE APPROPRIATE APPLICATION AND INSTALLED IN ACCORDANCE WITH MANUFACTURERS RECOMMENDATIONS.
17. MAJOR COMPONENTS OF EQUIPMENTS SHALL HAVE THE MANUFACTURER'S NAME, ADDRESS, TYPE OR STYLE, VOLTAGE AND CURRENT RATING, AND CATALOG NUMBER ON A NON-CORROSIVE AND NON HEAT SENSITIVE PLATE, SECURELY ATTACHED TO THE EQUIPMENT. ALL EQUIPMENT DELIVERED AND PLACED IN STORAGE, PRIOR TO INSTALLATION, SHALL BE PROTECTED FROM THE WEATHER, HUMIDITY AND TEMPERATURE VARIATION, DIRT AND DUST, AND ANY OTHER CONTAMINANTS. ALL EQUIPMENT SHALL BE IN NEW CONDITION, UNDAMAGED AND UNUSED.
18. THE PHRASE "PB-XX-M" ON CIRCUITS IN ELECTRICAL DRAWINGS SPECIFY THAT:
 - m :THE NUMBER OF THE CIRCUIT.
 - PB-XX :NUMBER OF THE PANEL/DISTRIBUTION BOARD THAT THE CIRCUIT IS ORIGINATE FROM.



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GENERAL NOTES:**EQUIPMENT SPECIFICATIONS****WIRING DEVICES**

1. MOUNTING HEIGHT OF SWITCHES 1200mm AFF UNLESS OTHERWISE NOTED.
2. MOUNT HEIGHT OF RECEPTACLES AND TELEPHONE/DATA OUTLETS 450mm AFF UNLESS OTHERWISE NOTED.
3. MOUNT HEIGHT OF TELEPHONE TERMINAL CABINET (COM) 1800mm FROM THE TOP OF CABINET TO FLOOR.
4. MOUNT HEIGHT OF ELECTRICAL PANELS 1800mm A.F.F. TO THE TOP OF THE PANEL.
5. DATA CABLE SHALL BE CAT 6, 4 PAIRS AND TELEPHONE CABLE CAT 5, 4 PAIRS.
6. FOR EXACT LOCATION OF MECHANICAL EQUIPMENT REFER TO MECHANICAL DESIGN DRAWINGS.
7. THE GROUNDING RESISTANCE SHALL BE NO HIGHER THAN 25 OHMS, EXCEPT IN THE GENERATOR, UPS AND EQUIPMENT ROOM SHALL BE 5 OHMS MEASURED MIN OF 48 HRS AFTER RAINFALL, ADDITIONAL RODS SHOULD BE USED TO ACHIEVED THE REQUIRED RESISTANCE.
8. ALL EXTERNAL ELECTRICAL PVC CONDUIT ARE UNDER GROUND MIN AT 800mm.
9. ALL PANEL BOARDS SHALL BE RATED FOR A MINIMUM 25 KAIC UNLESS OTHERWISE NOTED ON THE DRAWING.
10. SOCKETS (WATER PROOF) SHALL BE MOUNTED AT 1200mm AFF IN ALL WET/DUMP AREAS AND CONNECTED TO RCD CIRCUIT BREAKER, THE TRIP SETTING OF THE RCD CIRCUIT BREAKER SHALL BE 10mA OR LESS.
11. UNDER GROUND DISTRIBUTION SYSTEM WILL USE SCHEDULE 40 PVC CONDUIT UNDER ROADWAYS AND HIGH TRAFFIC AREAS ENCASE IN CONCRETE.
12. ALL DIRECT BURIED PVC CONDUIT SHOULD BE SCHEDULE 80.

RACEWAY

1. MINIMUM SIZE OF THE CONDUIT SHALL BE 20MM PVC, SCHEDULE 40 AND ALL INTERNAL WIRING SHOULD BE CONCEALED.
2. PROVIDE FLEXIBLE CONDUIT FOR MOTOR CONNECTIONS, AND FOR OTHER ELECTRICAL EQUIPMENT CONDITIONS, WHERE SUBJECT TO MOVEMENT AND VIBRATION 1800MM MAXIMUM LENGTH. PROVIDE LIQUID TIGHT FLEXIBLE CONDUIT FOR CONNECTION OF MOTOR AND FOR OTHER ELECTRICAL EQUIPMENT WHERE SUBJECT TO MOVEMENT AND VIBRATION, WHERE SUBJECT TO ONE OR MORE OF THE FOLLOWING CONDITIONS, UNLESS NOTED OTHERWISE:
 - MOIST AND HUMID ATMOSPHERE WHERE CONDENSATE CAN BE EXPECTED TO ACCUMULATE.
 - CORROSIVE ATMOSPHERE.
 - SUBJECT TO DRIPPING OIL, GREASE OR WATER.
3. ALL METAL CONDUITS SHALL BE GROUNDED PER NEC. CONDUITS ENTERING THE OUTLET BOXES, PANEL CABINETS ETC. MUST BE FITTED WITH A DOUBLE LOCKNUT AND BUSHING.

WIRES AND CABLES

1. ALL WIRE AND CABLE SHALL BE COPPER WITH THHN/THWN INSULATION AND ALL WIRE SIZES ARE BASED ON COPPER CONDUCTORS WITH 75°C INSULATION UNLESS INDICATED OTHERWISE. ALL CONNECTORS, LUGS, ETC. SHALL BE LISTED FOR 75°C.
2. CONDUCTORS INSTALLED UNDERGROUND OR IN THE WET LOCATIONS SHALL BE SUITABLE FOR WET LOCATIONS PER NEC.
3. ALL WIRE SHALL BE SINGLE CORE.
4. MINIMUM SIZE OF CONDUCTOR SHALL BE 2.5 SQ.MM.
5. CONDUCTOR 4 SQ.MM AND SMALLER SHALL BE SOLID, CONDUCTOR 6 SQ.MM AND LARGER SHALL BE STRANDED.

PANEL BOARDS:

1. PANELBOARD BUSBARS SHALL BE COPPER.
2. PANELBOARD ENCLOSURES: PROVIDE GALVANIZED SHEET CABINET, CODE - GAUGE, GUTTERS, PROVIDE FRONTS WITH ADJUSTABLE TRIM CLAMPS, AND DOORS WITH CONCEALED PIANO DOOR HINGES AND DOOR SWINGS AS INDICATED. EQUIPMENT WITH INTERIOR CIRCUIT-DIRECTORY FRAME AND CARD WITH CLEAR PLASTIC COVERING. PROVIDE BAKED GRAY ENAMEL FINISH OVER A RUST INHIBITOR COATING. DESIGN ENCLOSURES FOR RECESSED MOUNTING. PROVIDE ENCLOSURES WHICH ARE FABRICATED BY SAME MANUFACTURES AS PANEL BOARDS WHICH MATE AND MATCH PROPERLY WITH PANEL BOARD TO BE ENCLOSED.
3. CABINETS FOR DISTRIBUTION PANELS SHALL HAVE 6 cm OF GUTTER SPACE ON ALL SIDES AROUND PANEL BOARDS AND LIGHTING PANELS HAVE A MINIMUM OF 5 cm ON ALL SIDES AROUND PANEL BOARD.
4. ALL PANEL BOARDS SHALL BE EQUIPPED WITH COMMON KEY LOCKS. PROVIDE MINIMUM OF ONE KEY PER PANEL PLUS (8) SPARES.
5. NEW PANEL BOARDS SHALL BE AS INDICATED ON THE DRAWINGS, MOLDED CASE CIRCUIT BREAKERS AND COPPER BUS BARS. CIRCUIT BREAKERS AND INTERIORS SHALL BE OF THE SAME MANUFACTURER. THE PANEL BOARD SHALL COMPLY WITH ALL APPLICABLE STANDARDS.

ELECTRICAL BOXES AND FITTINGS

1. ALL BOXES AND FITTINGS SHALL BE PLASTIC BOXES.
2. JUNCTION AND PULL BOXES: PROVIDE PLASTIC JUNCTION AND PULL BOXES.
3. PROVIDE WEATHERPROOF OUTLETS FOR INTERIOR AND EXTERIOR LOCATIONS EXPOSED TO WEATHER OR MOISTURE.

FIRE ALARM NOTES

1. PROVIDE FIRE ALARM SYSTEM ON DESIGN-BUILD DRAWING.
2. ALL DEVICES AND EQUIPMENT FOR THIS SYSTEM SHALL CONFORM TO THE APPLICABLE SECTIONS OF NATIONAL FIRE PROTECTION ASSOCIATION (NFPA) 72 AND 90A.
3. THE INSTALLATION SHALL BE IN ACCORDANCE WITH ALL REQUIREMENTS OF NFPA 72, THE NATIONAL ELECTRICAL CODE (NEC), AND AED REQUIREMENTS.
4. UPON COMPLETION, THE SYSTEM SHALL BE THOROUGHLY TESTED BY THE CONTRACTOR TO ASSURE PROPER INTERFACING OF ALL COMPONENTS.
5. ALL WIRING FOR THE FIRE DETECTION AND ALARM SYSTEM SHALL BE RUN IN CONDUIT BY THE CONTRACTOR. ALL FIRE ALARM JUNCTION BOX COVERS SHALL BE PAINTED RED BY THE CONTRACTOR OR STENCILED FOR DISTINCT IDENTIFICATION. ALL CONDUIT, DEVICE MOUNTING BOXES, JUNCTION BOXES, AND PANELS SHALL BE SECURELY FASTENED BY THE CONTRACTOR WITH APPROPRIATE FITTINGS TO INSURE A POSITIVE GROUND THROUGHOUT THE ENTIRE SYSTEM.
6. ALL CONNECTIONS TO PANELS, DEVICES, AND DETECTORS SHALL BE MADE WITH CRIMP TYPE SPADE TERMINAL CONNECTORS. SPLICES IN STATION CIRCUITS SHALL BE MADE ONLY IN JUNCTION BOXES AND SHALL BE CRIMP CONNECTED.
7. ALL WIRING SHALL BE CHECKED AND TESTED BY THE CONTRACTOR TO INSURE THE SYSTEM IS FREE FROM GROUNDS, OPENS, AND SHORTS.

Designed by	Noor Ahmad	
Drawn by	Noor Ahmad	
Checked By Head of Department	Summer Gul	
Approved by Visa Committee	Jawed Hammad	

No.	Submission Description	Date
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SERVICES DIRECTORATE COMPLEX BUILDING
AOP
KABUL PROVINCE, AFGHANISTAN
POWER PLANT BUILDING
GENERAL NOTES

Sheet Reference Number
EG-500

LEGENDS

LIGHT FIXTURE SCHEDULE:

FIXTURE SYMBOLS	DESCRIPTION	MODULE
	36 WATTS, 600X800MM SURFACE MOUNTED LED LIGHTING FIXTURE, DIFFUSER COVER, COLOR TEMPERATURE (K) IS 4000, 220-240 V, 50-60Hz.	PAMIR MODERN LIGHTING FIXTURES, CODE:PL11U22E06C, LED TYPE:2835SMD OR EQUIVALENT TYPE
	14 WATT WATER PROOF LED LIGHTING FIXTURE , 220-240 V, 50-60Hz TEMPERATURE (K) IS 4000.	PAMIR MODERN LIGHTING FIXTURES, CODE:EAL12L15C, TYPE:2835SMD OR EQUIVALENT TYPE
	47 WATT WATER PROOF LED LIGHTING FIXTURE , 220-240 V, 50-60Hz TEMPERATURE (K) IS 4000.	PAMIR MODERN LIGHTING FIXTURES, CODE:EAL15C04C, TYPE:2835SMD OR EQUIVALENT TYPE

SWITCHES:

S	SINGLE POLE SWITCH, 220V, 50Hz, 10A, MOUNTED AT 1200mm AFF
Swp	SINGLE POLE WATER PROOF SWITCH, 220V, 50Hz, 10A, MOUNTED AT 1200mm AFF

LEGENDS

RECEPTACLES:

	SINGLE RECEPTACLE
	SINGLE RECEPTACLE WATER PROOF
	DUPLEX RECEPTACLE
	DUPLEX RECEPTACLE WATER PROOF

GROUNDING AND LIGHTNING:

	GROUNDING ROD 3m, Ø20mm
	ELECTRODE GROUNDING CONDUCTOR
	BONDING

PANEL BOARD

	MAIN DISTRIBUTION PANEL (MDP)
	SUB DISTRIBUTION PANEL (SDP)
	PANEL BOARD (PB)
	KILOWATT METER
	VOLT METER
	AMPERE METER

IEC WIRE COLORS (60227)

GROUND	NEUTRAL	PHASE A	PHASE B	PHASE C
YEL/GRN	BLUE	BROWN	BLACK	GRAY

ABBREVIATIONS

A	- AMPERE
ATS	- AUTOMATIC TRANSFER SWITCH
AFF	- ABOVE FINISH FLOOR
A.F.F.L	- ABOVE FINNISH FLOOR LEVEL
CU	- COPPER
E.H	- ELECTRICAL HANIDIOLE
C.H	- COMMUNICATION HANDHOLE
EMM	- ELECTRIC MEDIUM VOLTAGE MANHOLE
Ø.DIA	- DIAMETER
EF	- EXHAUST FAN
EMT	- ELECTRIC METALLIC TUBING
EWH	- ELECTRICAL WATER HEATER
FACP	- FIRE ALARM CONTROL PANEL
ELEC	- ELECTRICAL
MV	- MEDIUM VOLTAGE
GRS	- GALVANIZED RIGID STEEL
HZ	- HERTZ
JB	- JOINT BOX
MECH	- MECHANICAL
mm	- MILLIMETER
MDP	- MAIN DISTRIBUTION PANEL
MAX	- MAXIMUM
M	- METER
N.F.D.S	- NON FUSED DISCONNECT SWITCH
STLF	- SINGLE TUBE(1 LAMP 36W) LGHTING FIXTURE
SDP	- SUB DISTRIBUTION PANEL
PB	- PANEL BOARD
PMT	- PAD MOUNTED TRANSFORMER
RSC	- RIGID STEEL CONDUIT
PVC	- POLYVINYL CHLORIDE
RM	- ROOM
SF	- SUPPLY FAN
S.U	- SPLIT UNIT
TRANS	- TRANSFORMER
TTC	- TELEPHONE TERMINAL CABINET
TYP	- TYPICAL
TV	- TELEVISION
U.O.N	- UNLESS OTHERWISE NOTED
V	- VOLT
W	- WATT
WP	- WEATHER/WATER PROOF
PC	- PHOTOCELL

01 GENERAL NOTES AND SYMBOLS



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وزاریت مسکن و اداری
ریاست جمهوری دیپلماتیک امور
وزاریت پرقی

Tel: 0202143089 Website: www.aop.gov.af

Designed by	Noor Ahmad	
Drawn by	Noor Ahmad	
Checked By Head of Department	Summer Gull	
Approved by Visa Committee	Jawed Hammad	

No.	Description	Date
(01)	For Construction	1403/04/15
(02)		
(03)		
(04)		
(05)		

Contract No:	
Contract Date:	
Fiscal Year:	1403/1445
Drawn Code:	SDCB
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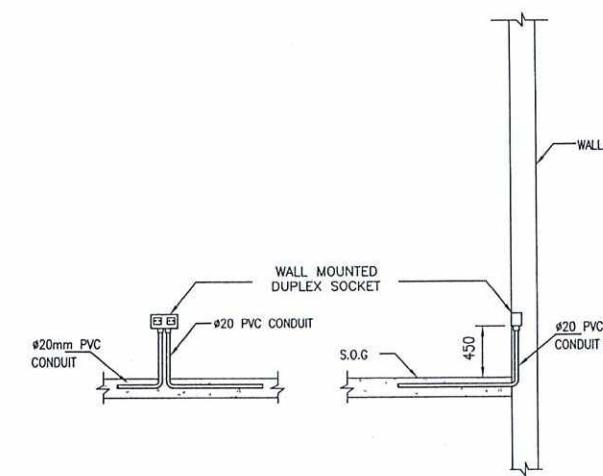
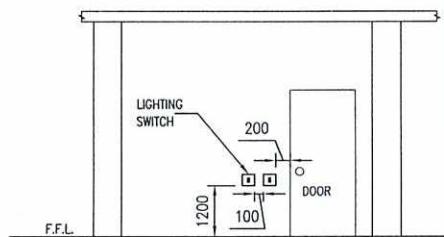
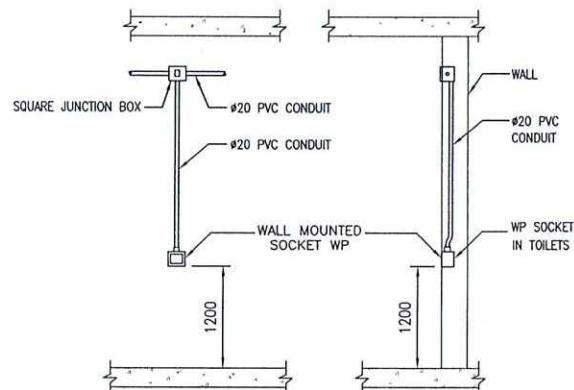
SERVICES DIRECTORATE COMPLEX BUILDING
AOP
KABUL PROVINCE, AFGHANISTAN
POWER PLANT BUILDING
GENERAL NOTES AND SYMBOLS

Sheet Reference Number
EG-501

GENERAL NOTES:

- ALL DIMENSIONS ARE IN MILLIMETER.
- ALL CONCEALED CONDUITS ARE PVC TYPE.


NOTE: LOCATION OF THE CONDUIT FEEDING THE FIRST SWITCH SHALL BE 100mm FROM THE DOOR OPENING.




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REF. SCALE: NTS

02 SWITCHE MOUNTING DETAILS
REF. SCALE: NTS

03 GENERAL INSTALLATION DETAIL FOR RECESSED SOCKET (CONDUIT EMBEDDED IN SLAB)
REF. SCALE: NTS

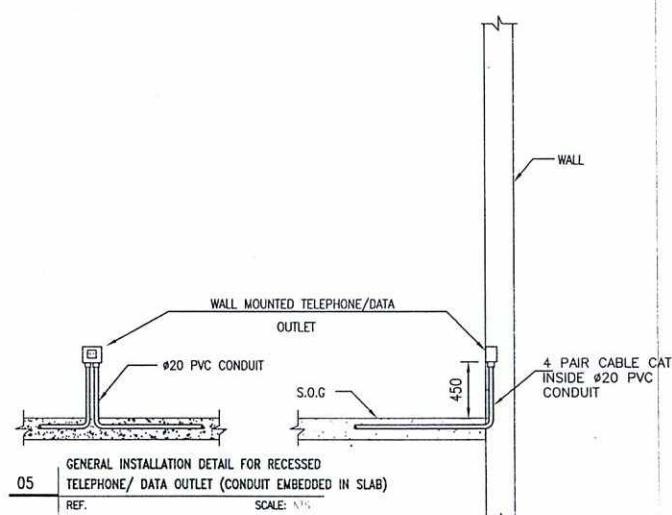

05 GENERAL INSTALLATION DETAIL FOR RECESSED TELEPHONE/ DATA OUTLET (CONDUIT EMBEDDED IN SLAB)
REF. SCALE: NTS

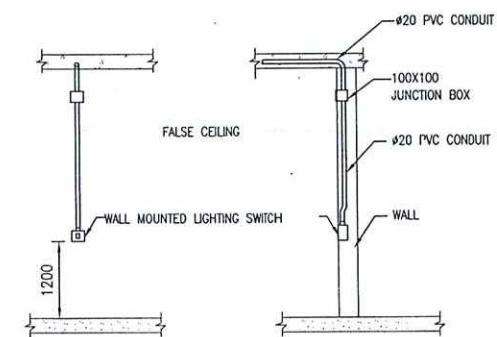

06 GENERAL INSTALLATION DETAIL FOR LIGHT SWITCH (CONCEALED CONDUIT)
REF. SCALE: NTS



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ریاست طرح و دیزاین امور ساختمانی

امریت سرق


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Drawn by:	Noor Ahmad	(02)			Contract Date
Checked By		(03)			Fiscal Year: 1403/1445
Head of Department:	Summer Gull	(04)			Drawn Code: SDCB
Approved by		(05)			Paper Size: A3
Visa Committee:	Jawed Hammad				Plot Date: 1403/04/09
					Scale: NTS

SERVICES DIRECTORATE COMPLEX BUILDING


AOP
KABUL PROVINCE, AFGHANISTANPOWER PLANT BUILDING
TYPICAL OUTLETS AND SWITCHES
MOUNTING DETAILS

Sheet Reference Number
EG-502

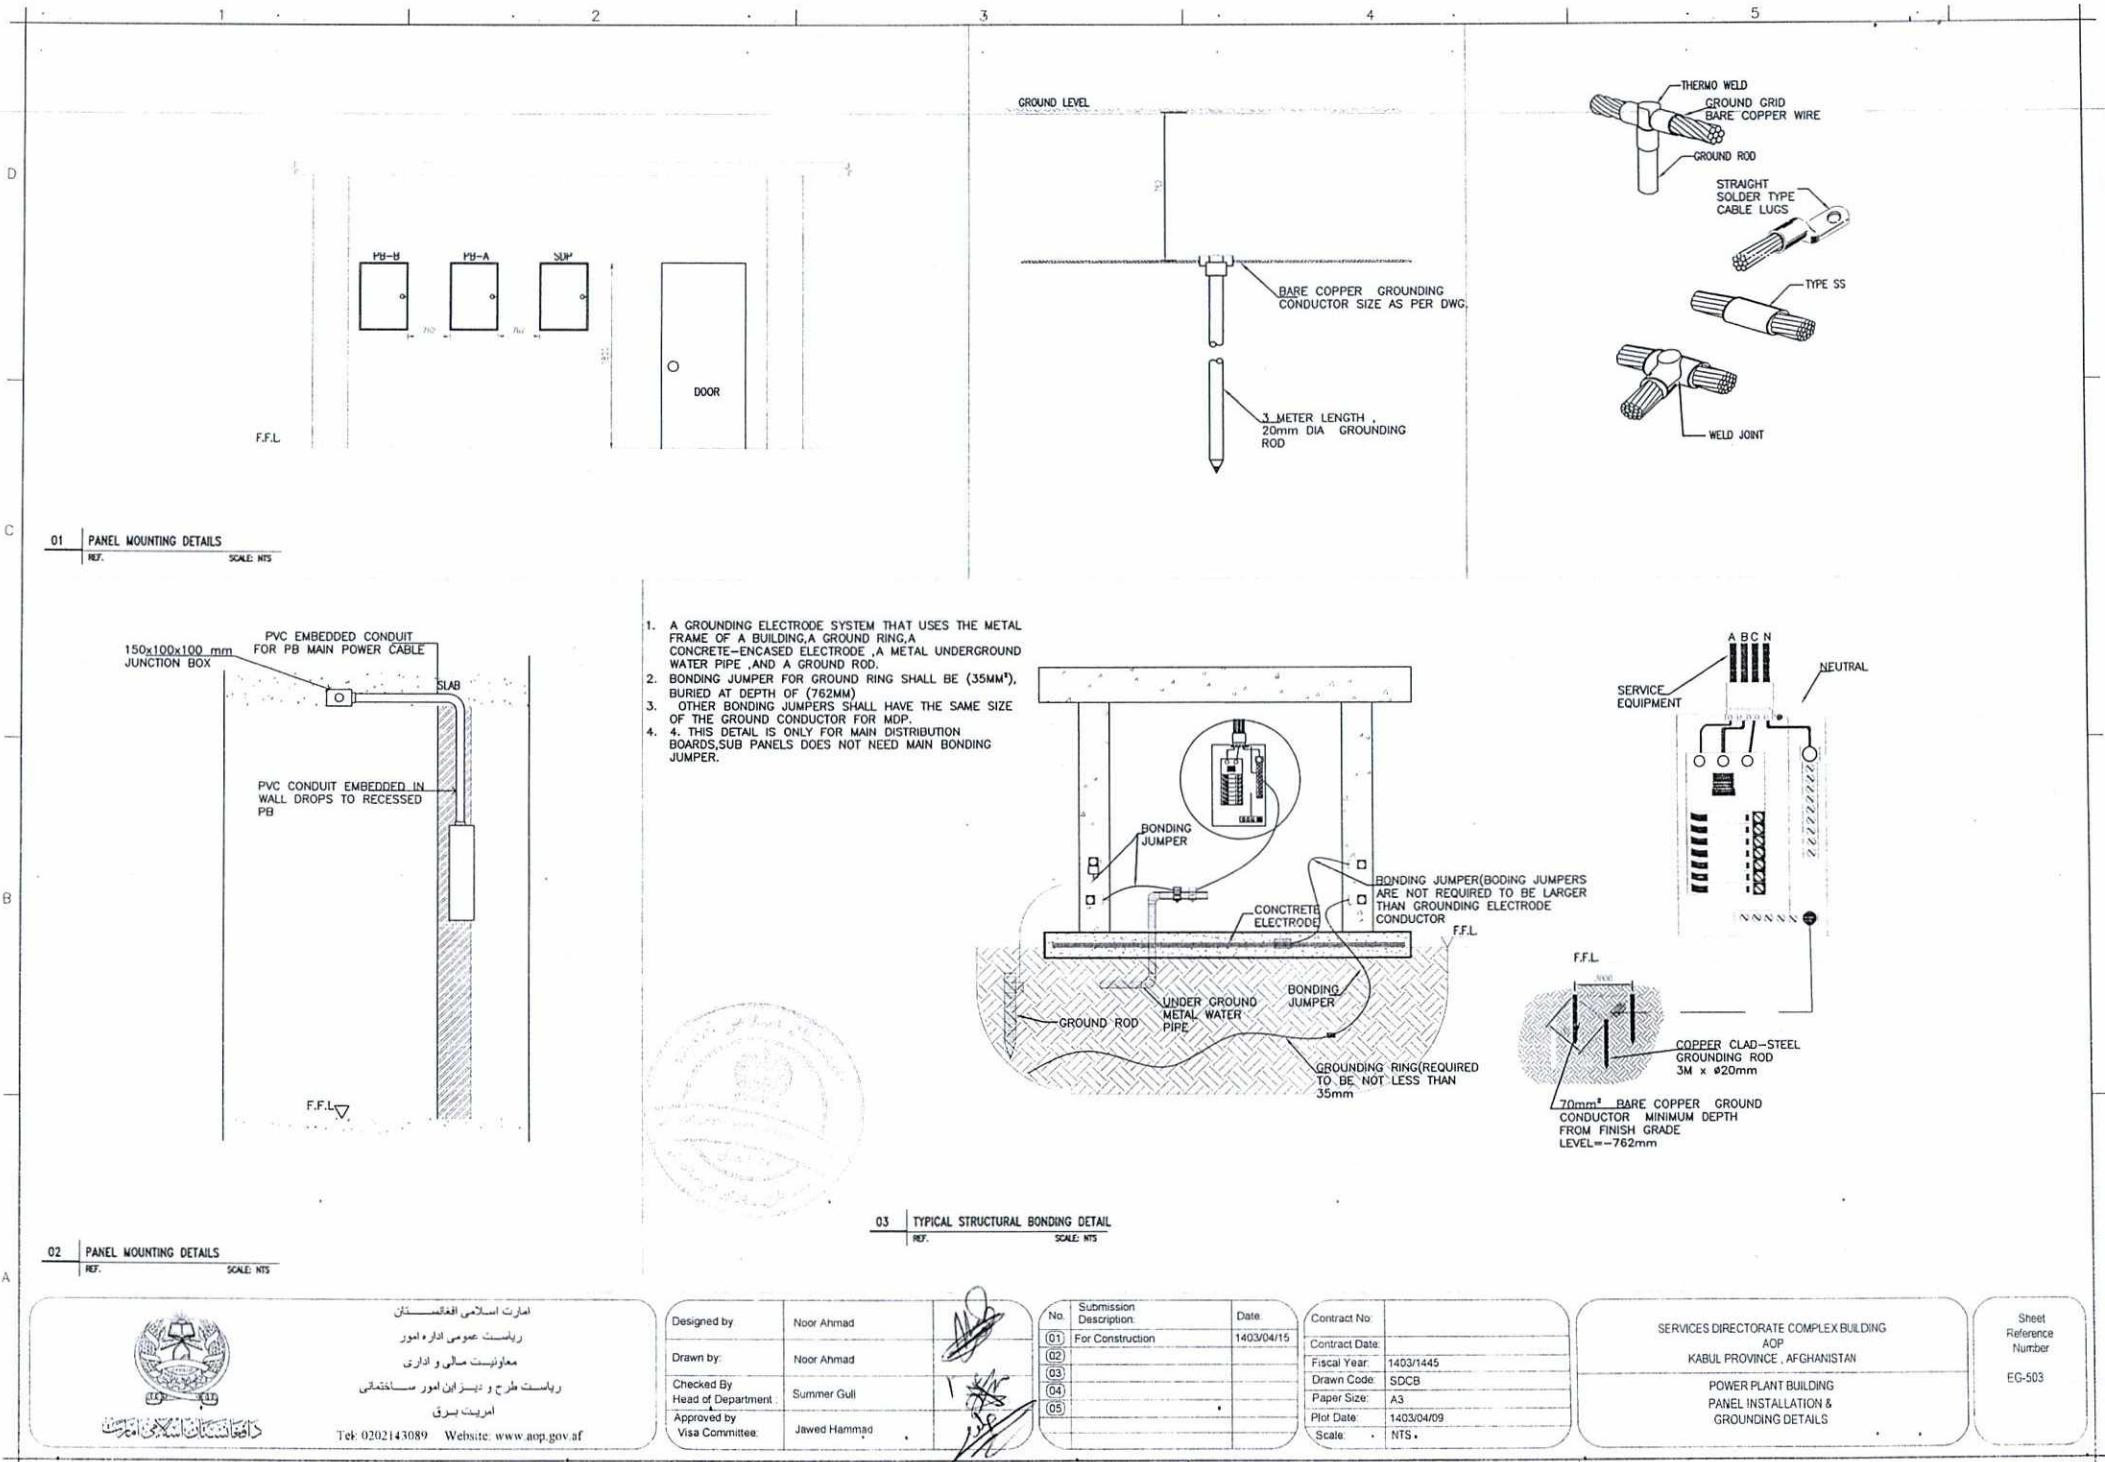

D

PB-P					
RECESSED MOUNTED NEMA-1				FEED FROM:MDP-01	
220 VOLTS, 1 PHASE, 3 WIRE				PANEL NAME: PB-P	
50 Hz PANEL BOARD				LOCATION: POWER PLANT BUILDING	
WIRE & CONDUIT GRN WIRE					
2(1Cx2.5mm ²) Ø20mm	2.5mm ²	DESCRIPTION	LOAD-VA	AMP	POLE
2(1Cx2.5mm ²) Ø20mm	2.5mm ²	LIGHTING	483	16	1
2(1Cx4mm ²) Ø20mm	4mm ²	LIGHTING	368	16	1
2(1Cx4mm ²) Ø20mm	4mm ²	RECEPTACLES	720	20	1
2(1Cx4mm ²) Ø20mm	4mm ²	RECEPTACLES	900	20	1
*	*	SPARE		20	1
		SPACE			5
					6
					7
					8
					9
					10
					11
					12
TOTAL CONNECTED LOAD				2.47	kVA
TOTAL DEMAND LOAD				2.33	kVA
25% FUTURE LOAD				0.58	kVA
TOTAL DEMAND LOAD + 25% FUTURE LOAD				2.91	kVA
TOTAL CURRENT				13.23	Amp
CIRCUIT BREAKER RATING				16.54	Amp
STANDARD CIRCUIT BREAK SIZE				25	Amp

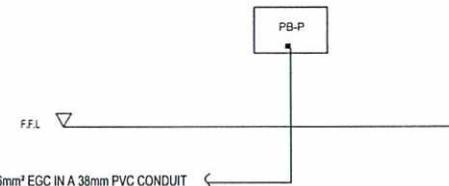

01 | PANEL SCHEDULE
REF. :
SCALE: 1:100



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ریاست طرح و نیزیان امور ساختمانی

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Checked By Head of Department: Summer Gull
Approved by Visa Committee: Jawed Hammad

No.	Submission Description	Date:
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(02)		
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(05)		

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SERVICES DIRECTORATE COMPLEX BUILDING
AOP
KABUL PROVINCE, AFGHANISTAN

POWER PLANT BUILDING
PANEL SCHEDULE

Sheet Reference Number
PP-E-601


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380Y / 220 VOLTS, 3 PHASE, 5 WIRE		MDP-01														FEED FROM: TRANSFORMER STATION				
50Hz PANEL BOARD		1000 AMP MAIN BREAKER														MOUNTED: SURFACE MOUNTED NEMA-1 ENCLOSURE				
25 KAIC FOR 0.5 SEC																LOCATION: ELECTRICAL ROOM				
WIRE & CONDUIT	GND WIRE	DESCRIPTION	A	B	C	AMP	POLE	CKT	A	B	C	CKT	POLE	AMP	A	B	C	DESCRIPTION	GND WIRE	WIRE & CONDUIT
-	-	-	0	-	-	-	-	1	2	-	-	-	-	0	-	-	-	-	-	
1(4Cx95mm ²) EXISTING	EXISTING	پالس بورد تعمیر روابط علیه	0	-	-	400 (EXISTING)	3	3	4	3	250 (EXISTING)	0	-	0	پالس بورد تعمیر عربیش	EXISTING	1(4Cx70mm ²)EXISTING			
-	-	-	0	-	-	-	-	5	6	-	-	-	-	0	-	-	-	-	-	
1(4Cx50mm ²) EXISTING	EXISTING	پالس بورد چک نوم	0	-	-	400 (EXISTING)	3	9	10	3	250 (EXISTING)	0	-	0	پالس بورد تک نیسل	EXISTING	1(4Cx35mm ²)EXISTING			
-	-	-	0	-	-	-	-	11	12	-	-	-	-	0	-	-	-	-	-	
-	-	-	0	-	-	-	-	13	14	-	-	-	-	-	-	-	-	-	-	
1(4Cx50mm ²) EXISTING	EXISTING	پالس بورد چک روزه	0	-	-	250 (EXISTING)	3	15	16	3	400	-	-	-	SPARE	-	-	-	-	
-	-	-	0	-	-	-	-	17	18	-	-	-	-	-	-	-	-	-	-	
1(4Cx6mm ²) EXISTING	EXISTING	پالس بورد گدام	0	-	-	250 (EXISTING)	3	21	22	3	250	-	-	-	SPARE	-	-	-	-	
-	-	-	0	-	-	-	-	23	24	-	-	-	-	-	-	-	-	-	-	
1(2Cx6mm ²) Ø38mm	6mm ²	پالس بورد دنخس سرچ سرق	2565	-	-	25	1	25	26	-	-	-	-	-	-	-	-	-	-	
				-	-	-	-	27	28	-	-	-	-	-	-	-	-	-	-	
				-	-	-	-	29	30	-	-	-	-	-	-	-	-	-	-	
				-	-	-	-	31	32	-	-	-	-	-	-	-	-	-	-	
				-	-	-	-	33	34	-	-	-	-	-	-	-	-	-	-	
				-	-	-	-	35	36	-	-	-	-	-	-	-	-	-	-	
				-	-	-	-	37	38	-	-	-	-	-	-	-	-	-	-	
				-	-	-	-	39	40	-	-	-	-	-	-	-	-	-	-	
				-	-	-	-	41	42	-	-	-	-	-	SUB - TOTAL					
TOTAL PHASE A		2565.00	0	0.00										0.00	0.00	0	SUB - TOTAL			
TOTAL PHASE B		0.00	0.00																	
TOTAL PHASE C		0.00	0.00																	
TOTAL CONNECTED LOAD		2.57	KVA																	
TOTAL DEMAND LOAD		0.00	KVA																	
25% FUTURE LOAD		0.00	KVA																	
TOTAL DEMAND+25% FUTURE LOAD		0.00	KVA																	
TOTAL CURRENT		0.00	Amp																	
CIRCUIT BREAKER RATING		0.00	Amp																	
SI ANDAHU CIRCUIT BREAKER		1UUU	Amp																	

نوت
ظرفیت پریکر های تعمیرات موجود به اساین سینگل لاین دیاگرام ایکه از طرف
ریاست حفظ و مرافقیت رسما ارسال گردیده بود درنظر گرفته شده.

MDP-01

F.F.L.


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REF. SCALE: 1:250

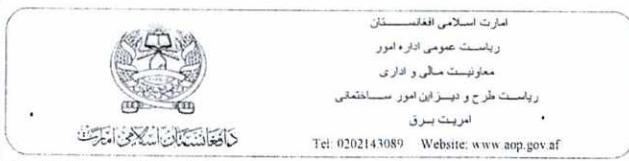Designed by	Noor Ahmad								
Drawn by	Noor Ahmad								
Checked By Head of Department	Summer Gul								
Approved by Visa Committee	Jawed Hammad								
No.	Submission Description	Date							
(G1)	For Construction	1403/04/15							
(G2)									
(G3)									
(G4)									
(G5)									

Contract No	
Contract Date	
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Scale	1:250

SERVICES DIRECTORATE COMPLEX BUILDING
AOP
KABUL PROVINCE, AFGHANISTAN
POWERPLANT BUILDING
PANEL SCHEDULE

Sheet Reference Number
PP-E-602

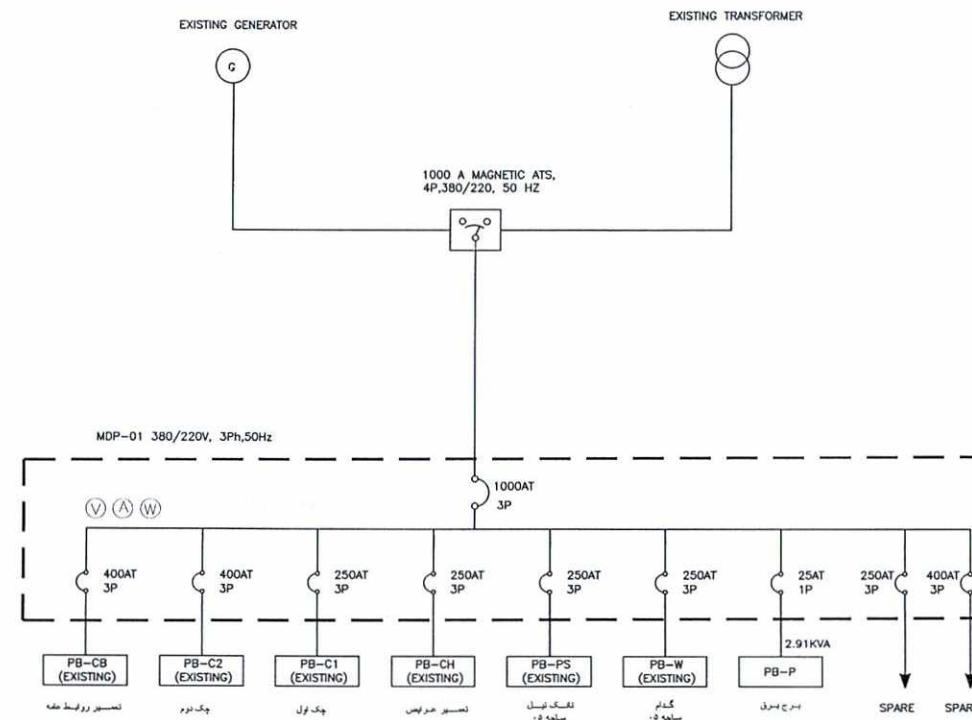

01 | SINGLE LINE DIAGRAM
REF. SCALE NTS



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Approved by Visa Committee: Jawed Hammad


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SERVICES DIRECTORATE COMPLEX BUILDING
AOP
KABUL PROVINCE, AFGHANISTAN
POWER PLANT BUILDING
SINGLE LINE DIAGRAM

Sheet Reference Number
PP-E-603

1 2 3 4 5



01 | LIGHTING PLAN
REF. SCALE 1:75

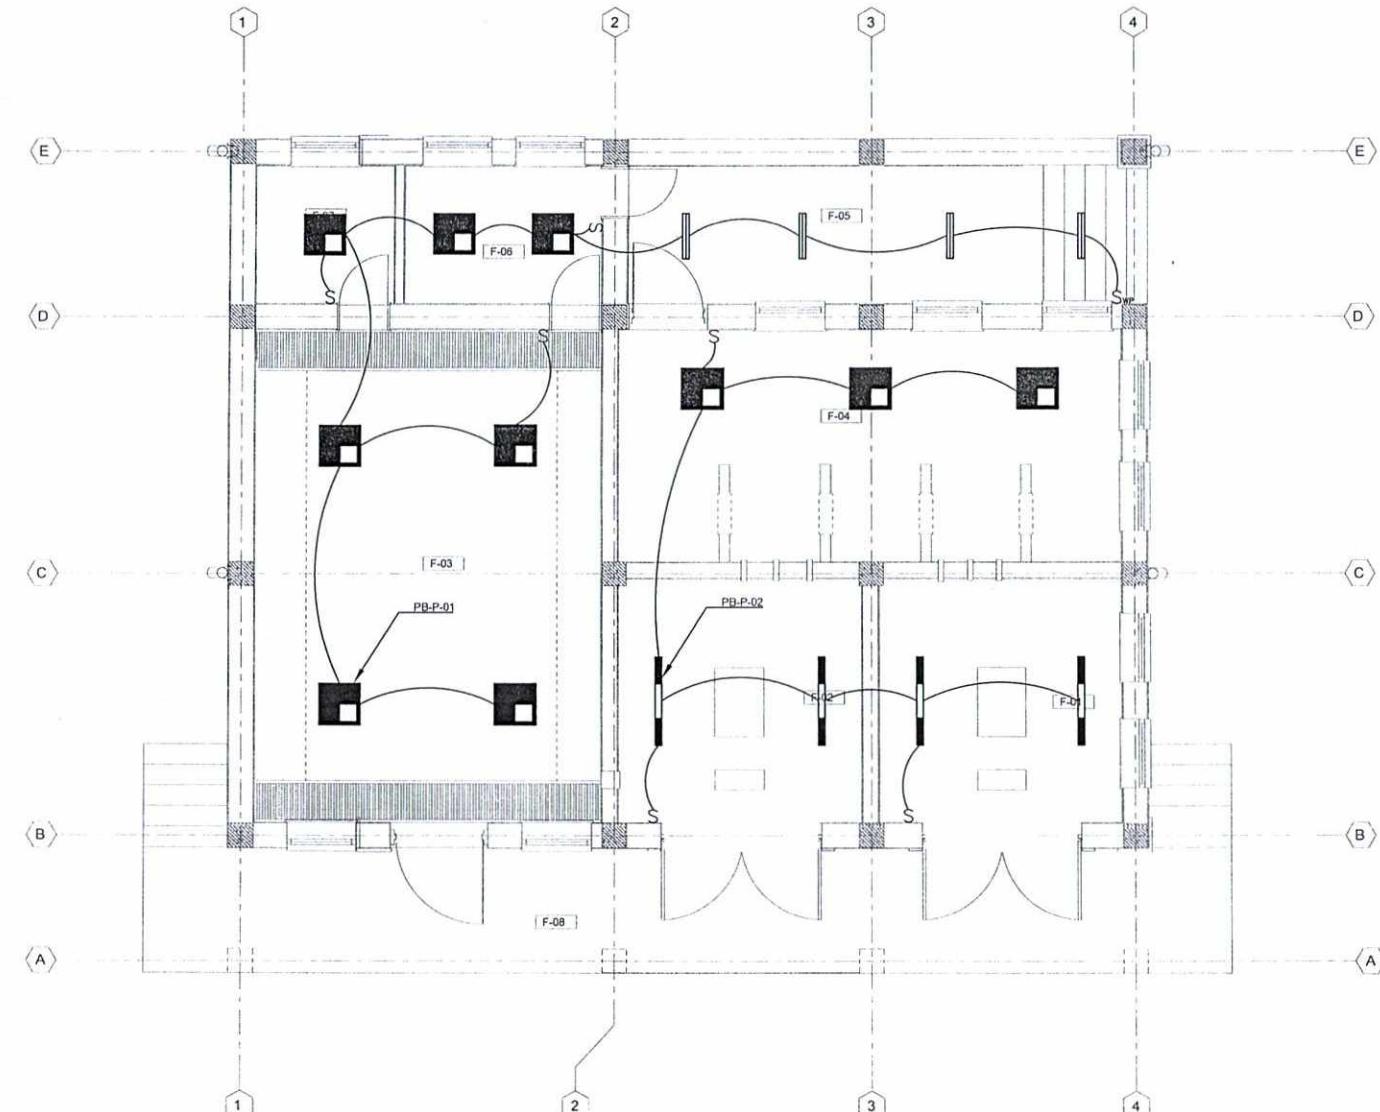

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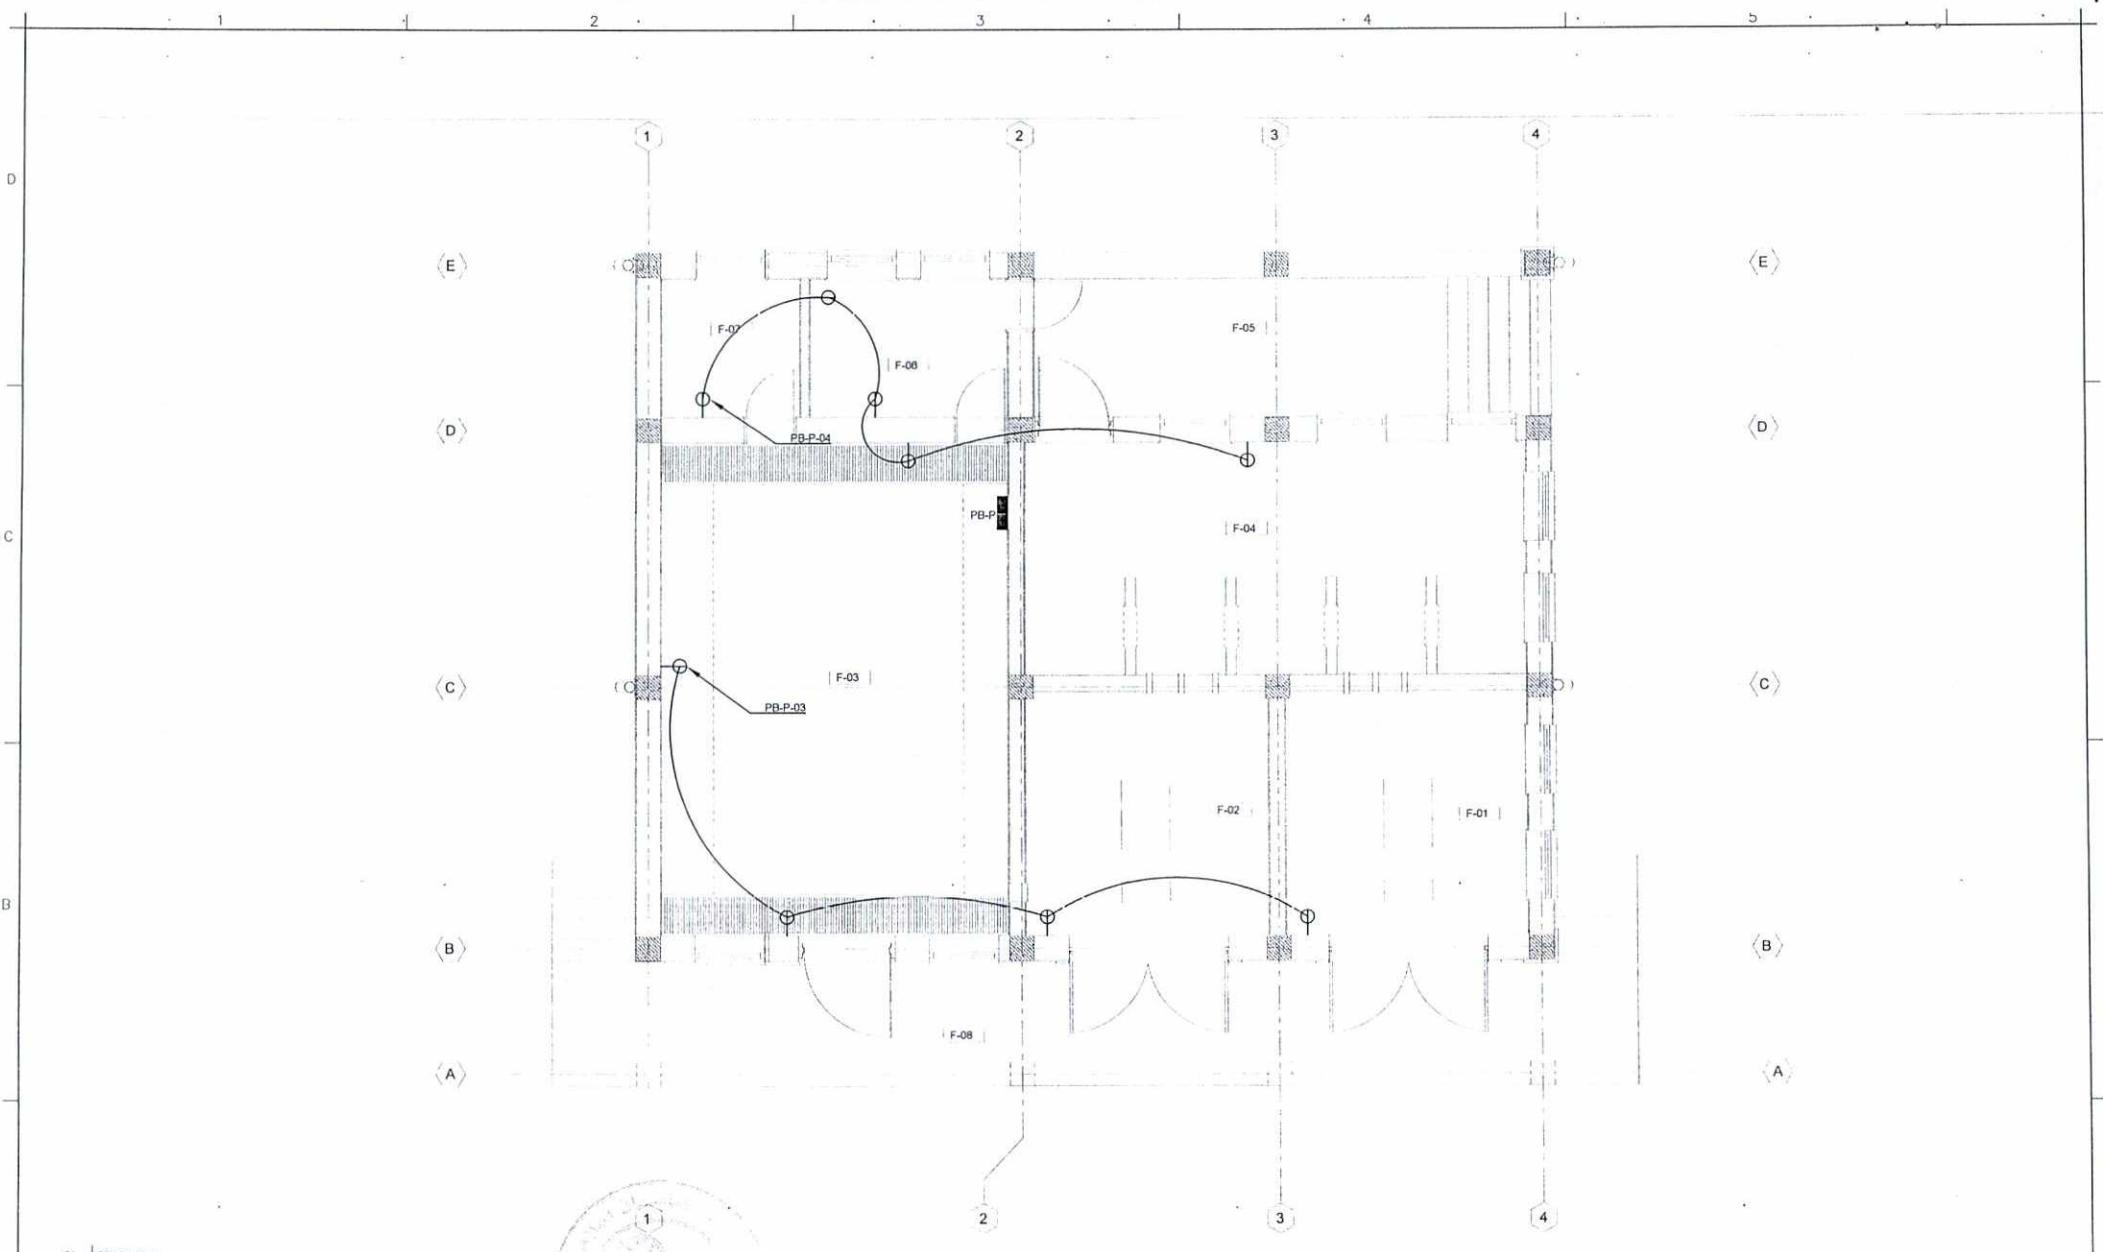
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Checked By Head of Department:	Summer Gull	
Approved by Visa Committee:	Jawed Hammad	

No.	Submission Description	Date
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(05)		

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Draw Code: SDCB
Paper Size: A3
Plot Date: 1403/04/09
Scale: 1:75

SERVICES DIRECTORATE COMPLEX BUILDING
AOP
KABUL PROVINCE, AFGHANISTAN
POWER PLANT BUILDING
LIGHTING PLAN

Sheet Reference Number
PP-E-101



01 POWER PLAN
REF. SCALE: 1:75



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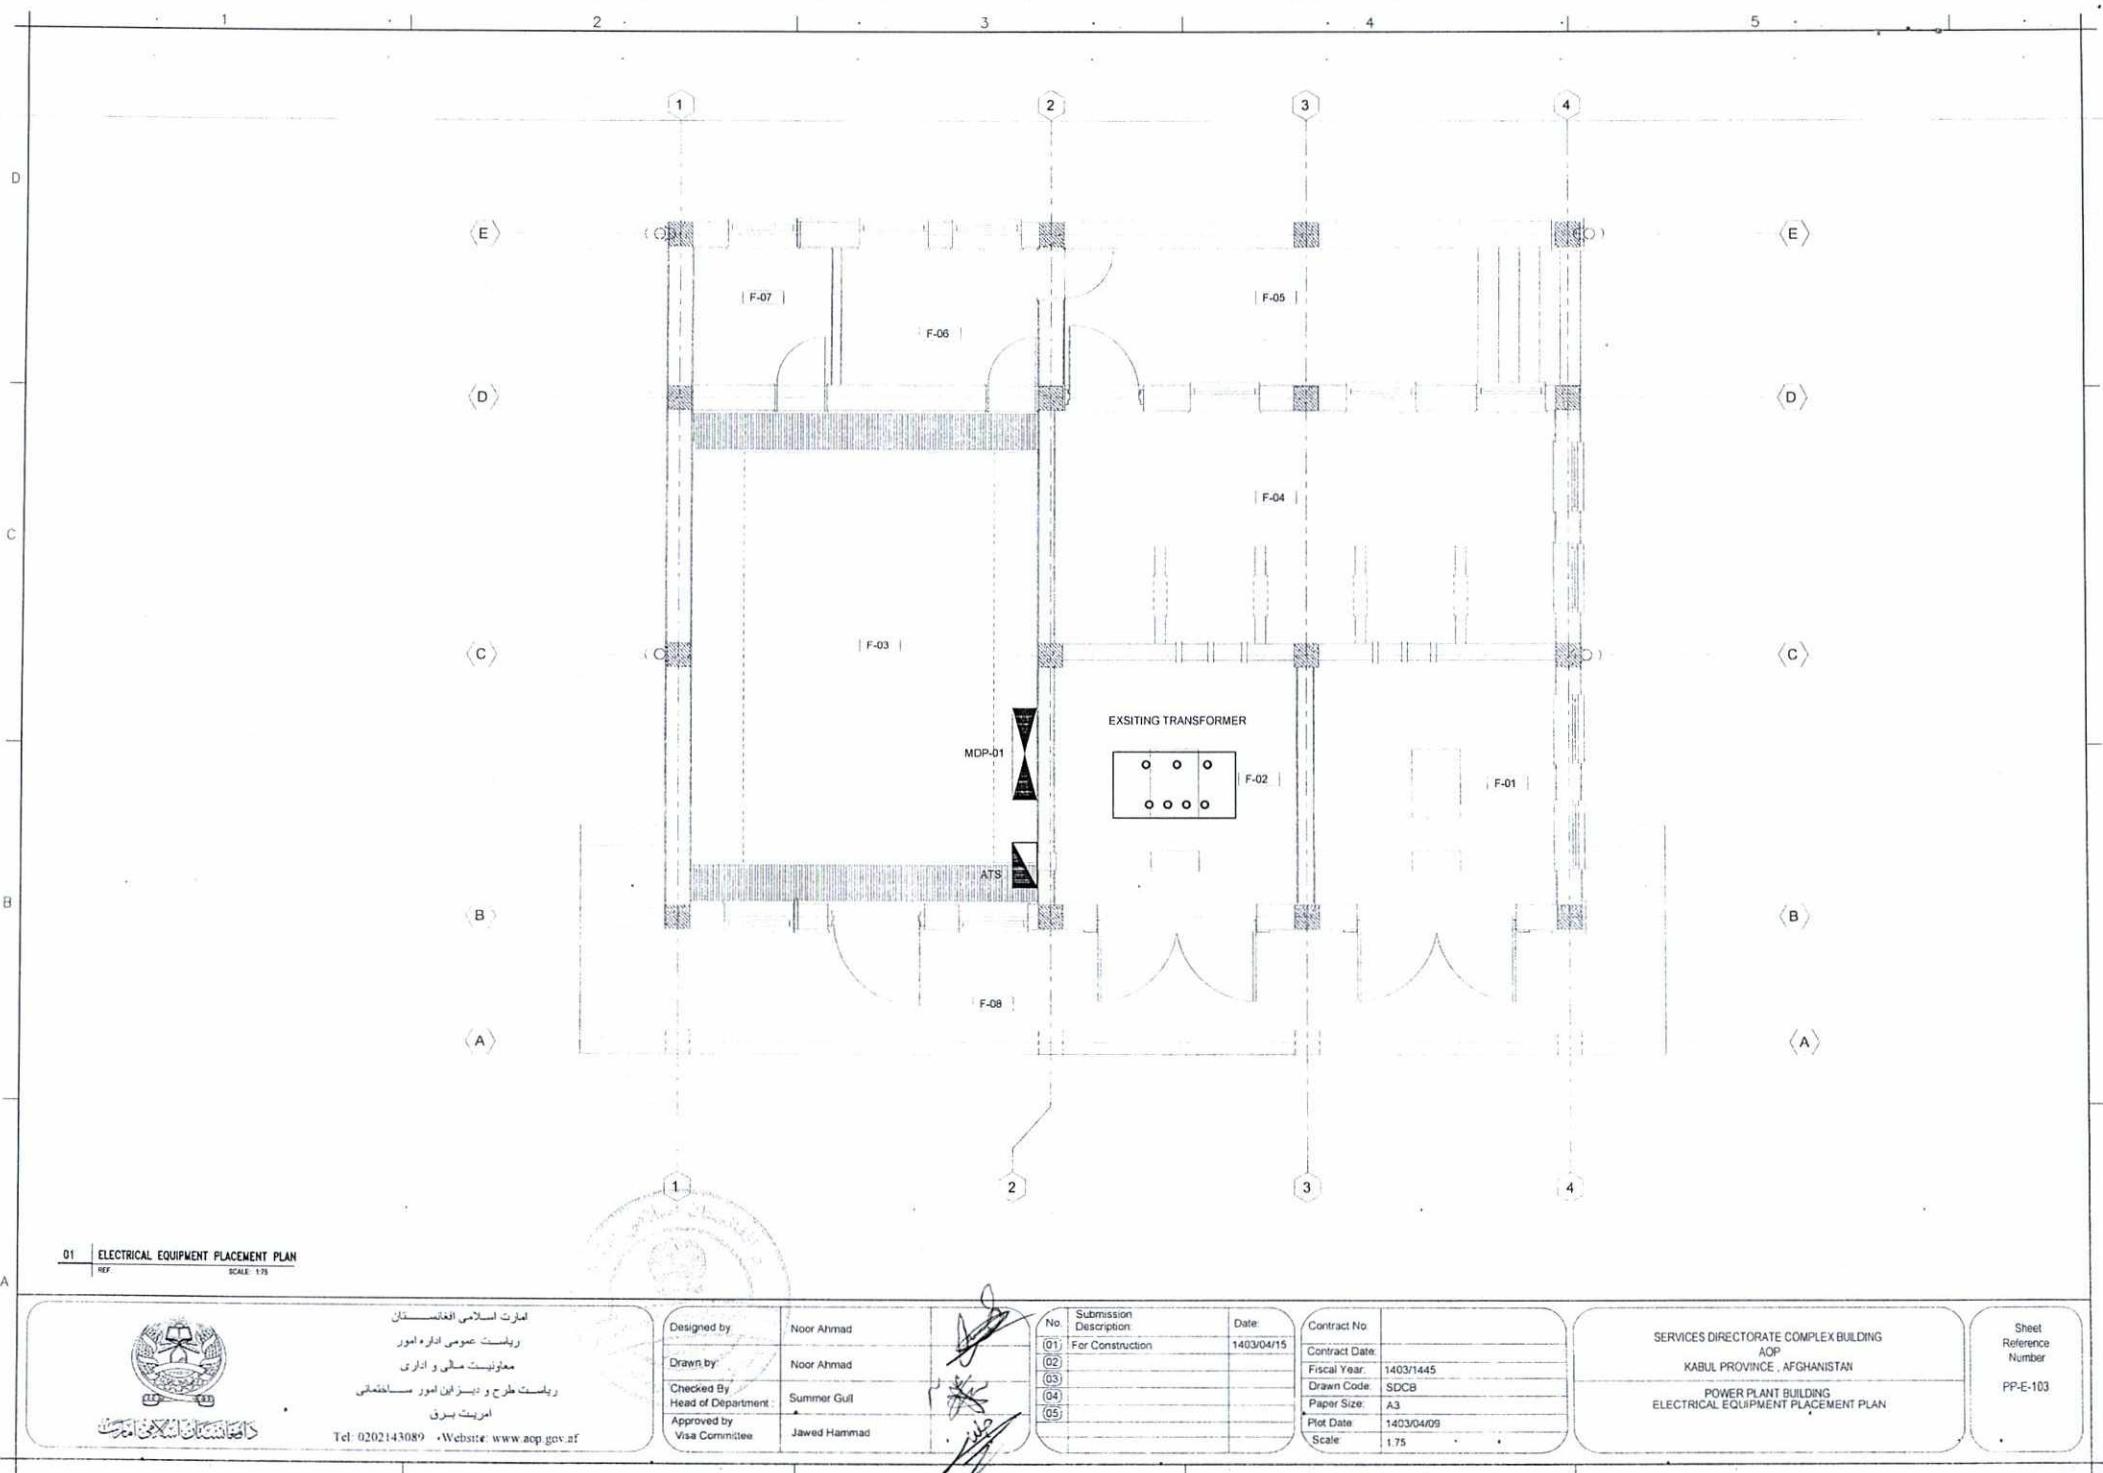
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Approved by Jawed Hammad


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Contract No.	Contract Date

SERVICES DIRECTORATE COMPLEX BUILDING
AOP
KABUL PROVINCE, AFGHANISTAN
POWER PLANT BUILDING
POWER PLAN

Sheet Reference Number
PP-E-102



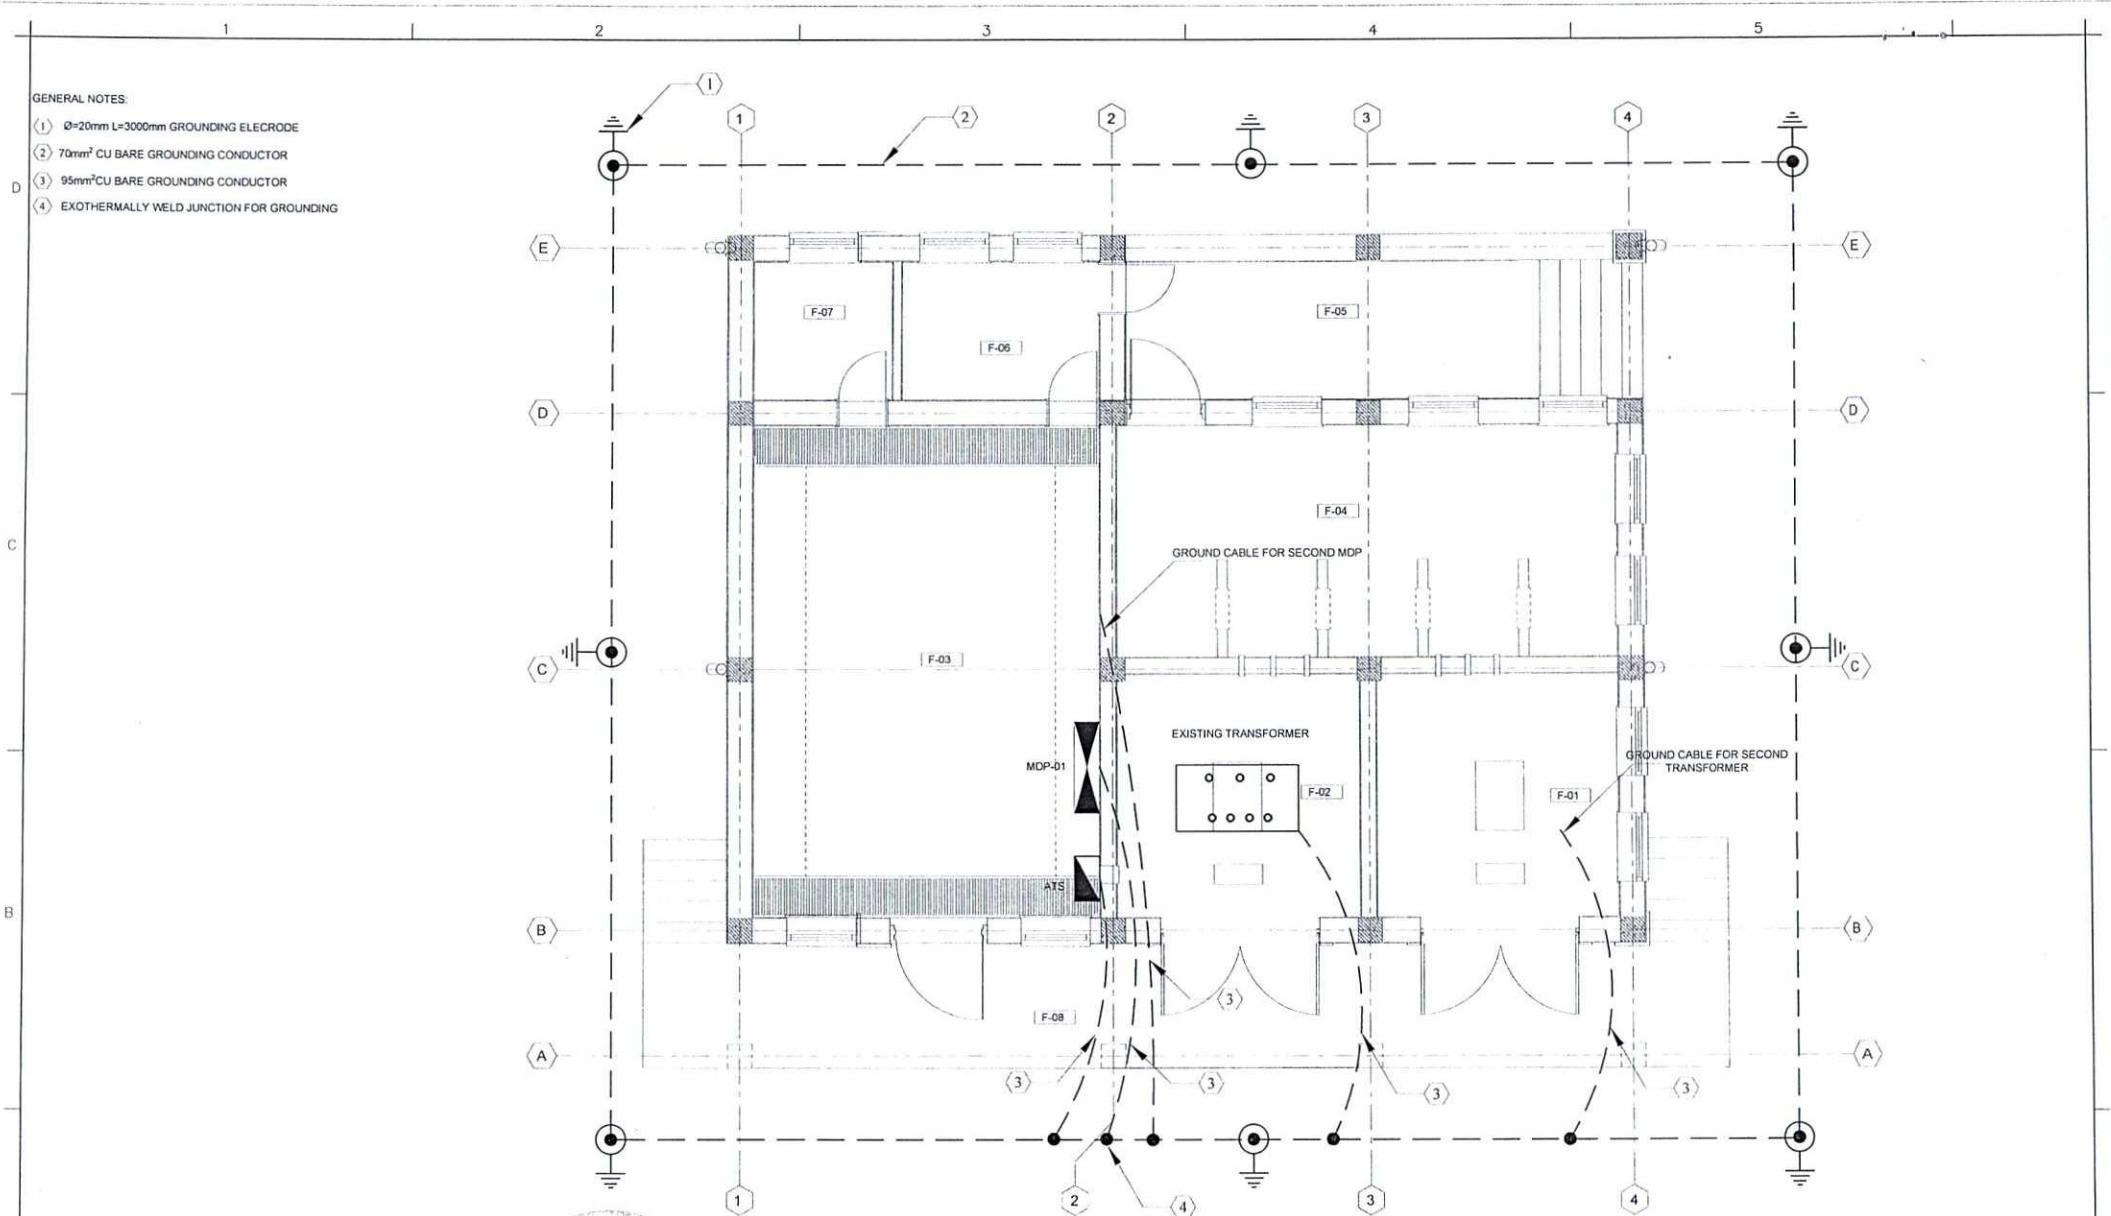

01 GROUNDING PLAN
REF. SCALE 1:75



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Approved by Visa Committee:	Jawed Hammad	(03)	
		(04)	
		(05)	

SERVICES DIRECTORATE COMPLEX BUILDING
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KABUL PROVINCE, AFGHANISTAN
POWER PLANT BUILDING
GROUNDING PLAN

Sheet Reference Number
PP-E-104



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امارت اسلامی افغانستان

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آمریت میخانیک و آبرسانی

نقشه های میخانیک

تعمیر کمپلکس ریاست خدمات

برج برق ساحه ۵۰

کابل — افغانستان



INDEX SHEET



دافتار انتخابات اسلامی امیرکبیر

امارت اسلامی افغانستان
ریاست عمومی اداره امور
معارنیت ملی و اداری
ریاست طرح و پیزبانی امور ساختهای
اموریت مخاتبیک و ابر-سازی

Designed by:	FARZAD DAWOODZAI
Drawn by:	FARZAD DAWOODZAI
Checked By	NAJIBULLAH HUSAIN KHL
Head of Department :	
Approved by	M.AMIR
Visa Committee:	

No.	Submission Description:	Date:	Contract No.:
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02			Fiscal Year:
03			Drawn Code:
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05			Plot Date:
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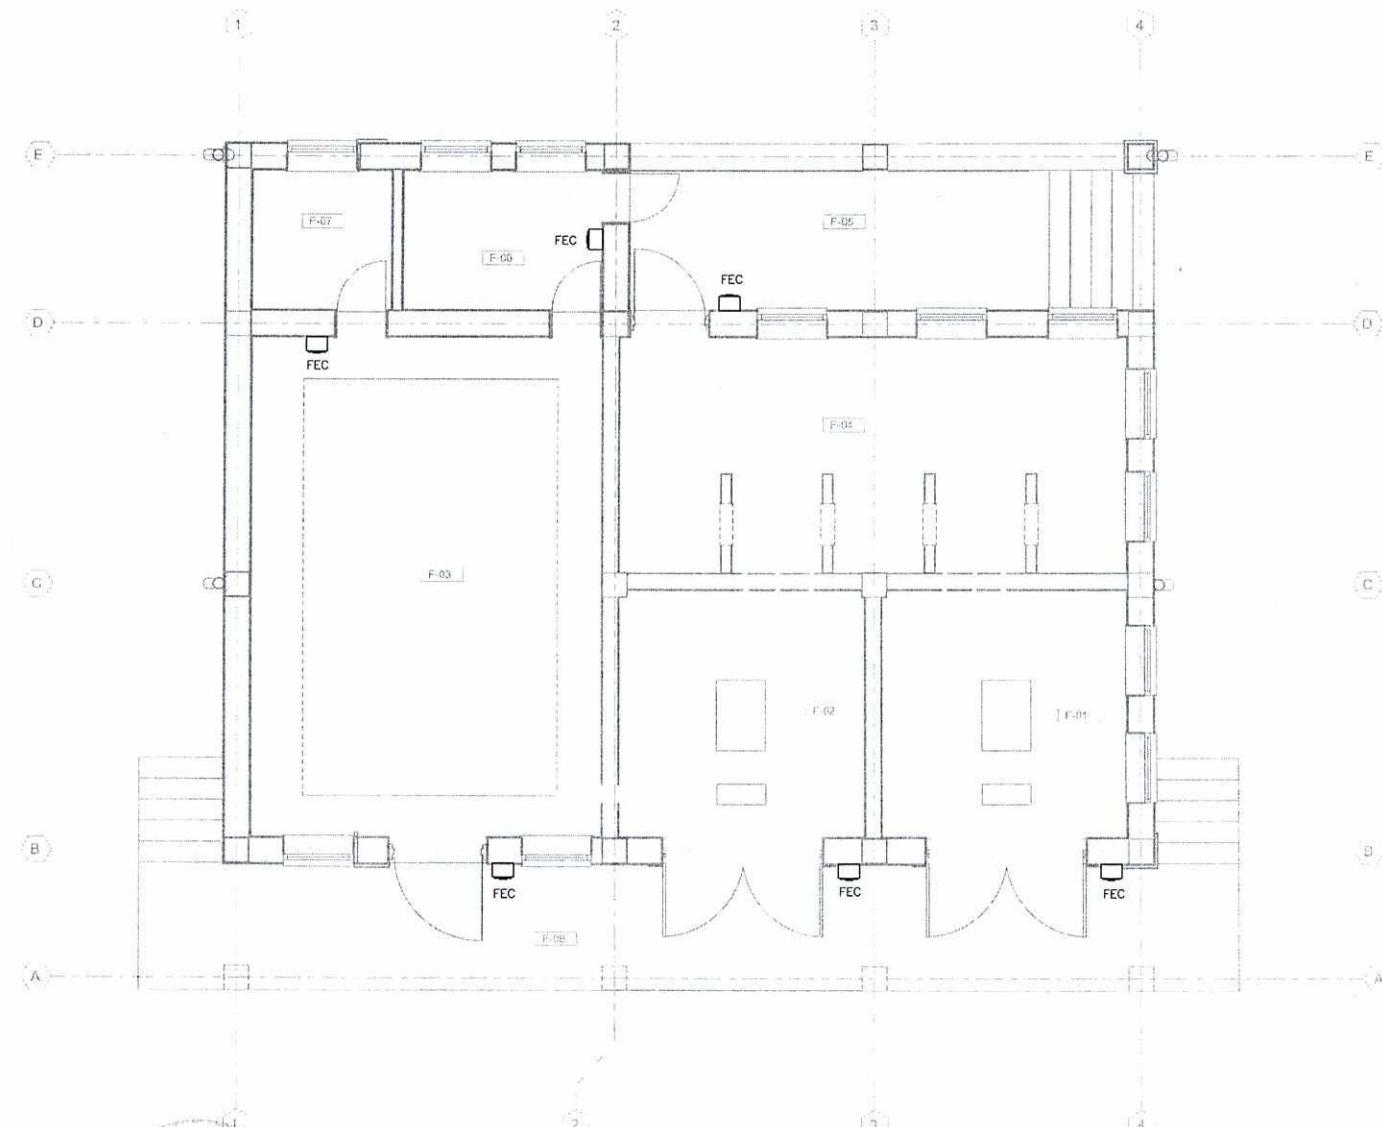
SERVICES DIRECTORATE COMPLEX BUILDING
AOP
KABUL PROVINCE, AFGHANISTAN

POWER PLANT BUILDING
INDEX SHEET

Sheet
Reference
Number

G-001

1 2 3 4 5



0 0.375 0.75 1.5 2.25 3.0 3.75
GRAPHIC SCALE: 1:75 (M)

01 FIRE EXTINGUISHER PLAN
PP-M101 REF. SCALE: 1:75



اسلامی افغانستان
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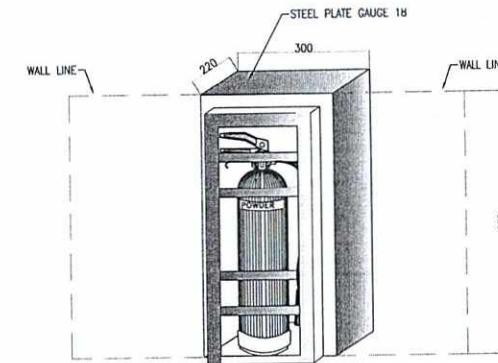
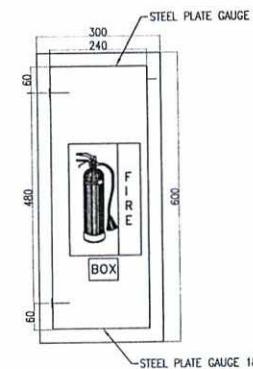
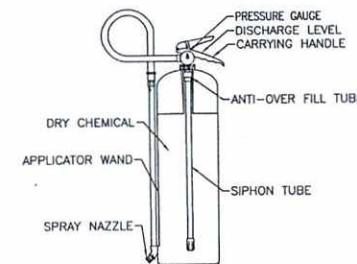
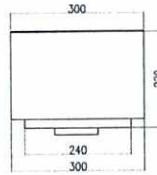
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Drawn by:	FARZAD DAWOODZAI		(01) For Construction	1403/04/15
Checked By / Head of Department:	NAJIBULLAH HUSAIN KHALI		(02)	
Approved by / Visa Committee:	M.AMIR		(03)	
			(04)	
			(05)	

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SERVICES DIRECTORATE COMPLEX BUILDING
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POWER PLANT BUILDING
FIRE EXTINGUISHER PLAN

Sheet
Reference
Number
PP-M101

NOTE:
FIRE EXTINGUISHER SHALL BE INSTALLED 1.5 M ABOVE THE FINISHING FLOOR



01 FIRE EXTINGUISHER BOX TOP VIEW

PP-M501 REF.

SCALE: NTS

02 FIRE EXTINGUISHER CYLINDER DETAIL

PP-M501 REF.

SCALE: NTS

03 FIRE EXTINGUISHER FRONT VIEW

PP-M501 REF.

SCALE: NTS

04 FIRE EXTINGUISHER BOX DETAIL

PP-M501 REF.

SCALE: NTS

FIRE EXTINGUISHER (FE)									
TYPE	DIAMETER (mm)	HEIGHT (mm)	CAPACITY (kg)	APPROXIMATE FULL WEIGHT (kg)	WORKING TEMPERATURE RANGE	WORKING PRESSURE(bar)	TEST PRESSURE(bar)	APPROXIMATE DISCHARGE RANGE(m)	FIRE CLASS
STORED PRESSURE TYPE	178	587	9	13.1	-20 to +60 °C	12	25	6-7.5	C

05 FIRE EXTINGUISHER SCHEDULE

PP-M501 REF.

SCALE: NTS

ABBREVIATION



:= FIRE EXTINGUISHER CABINET (FEC)



امانت اسلامی افغانستان

رواست حومی اداره امور

مختاری مالی و اداری

رواست طرح و هزای امور ساختاری

امور مخابرات و ابرسانی

Tel: 0202143089 Website: www.aop.gov.af

Designed by:

Drawn by:

Checked By

Head of Department:

Approved by

Visa Committee:

M.AMIR

No.

Submission Description:
For Construction

Date:

1403/04/15

Contract No:

(01)

Contract Date:

1403/1445

Fiscal Year:

SDCB

Drawn Code:

Paper Size:

Plot Date:

Scale:

A3

1403/04/09

NTS

SERVICES DIRECTORATE COMPLEX BUILDING
AOP

KABUL PROVINCE, AFGHANISTAN

POWER PLANT BUILDING

FIRE EXTINGUISHER DETAILS

Sheet Reference Number

PP-M501